# RANCHO SANTIAGO COMMUNITY COLLEGE DISTRICT



# **ADDENDUM NO. 03**

# Bid #1456 CAMPUS ENTRANCE IMPROVEMENTS PROJECT at SANTA ANA COLLEGE

Address: 1530 West 17th Street, Santa Ana, CA 92706

Project ID #3276, DSA #04-122485

June 20, 2024

# Owner:

Rancho Santiago Community College District 2323 North Broadway, Room 112 Santa Ana, California 92706

# RECEIPT OF THIS ADDENDUM MUST BE ACKNOWLEDGED ON BID FORM WHEN SUBMITTED

The following changes, additions, deletions or corrections shall become a part of the Contract Documents for the project named on the previous page and all other conditions shall remain the same. The Bidders shall be responsible for transmitting this information to all affected Subcontractors and Suppliers, prior to the closing of Bids. Prospective Bidders shall acknowledge receipt of all Addenda in the space provided on the Bid Proposal Form by the number (list every addenda). Failure to do so shall deem the Bid Proposal as non-responsive and subject the Bidder to disqualification.

# Item No. AD 3-1 Extension of Bid Due Date (see revised date in red)

Submittal of Bid Proposals. All Bid Proposals must be submitted on forms furnished by the District prior to 2:00 P.M., Wednesday, May 15, 2024, Thursday, June 20, 2024 Tuesday, July 9, 2024, the last time for submission of Bid Proposals and the District's public opening and reading of Bid Proposals. Submit Bids to RSCCD Facility Planning, Construction and District Support Services at 2323 North Broadway, Suite 112, Santa Ana, CA 92706. Bidders are solely responsible for timely submission of Bid Proposals to the District at the designated location. The District shall not be responsible for any delays or issues with mail delivery. Any bid received after the scheduled closing time for receipt of bids shall be returned to the bidder unopened. Bid Summary will be posted on the District's website (www.rsccd.edu then click on "Bid Opportunities").

# Item No. AD 3-2 DSA Addendum to Construction Documents

See attached DSA Addendum No. 1 & 2 for revisions to the Construction Documents

# Item No AD 3-3 Logistics Plan

See attached Appendix "A" Logistics Plan

# Item No AD 3-4 Supplementary Conditions

See attached revised Supplementary Conditions

**Enclosures** 

This is the end of Addendum No. 03

# Addendum #03

ARCHITECTS

Santa Ana + Oakland + San Diego + Honolulu

SVA Architects. Inc.

6 Hutton Centre Drive, Suite 1150 Santa Ana, California 92707 T 949.809.3380

info@sva-architects.com www.sva-architects.com

Project: Santa Ana College Campus Entrance Improvements

Owner: Rancho Santiago Community College District

2323 N. Broadway, Suite 112, Santa Ana, CA 92706-1640

Project Manager: Paul Smith, RSCCD

**Architect:** SVA Architects, Inc.

3 MacArthur Place, Suite 850, Santa Ana, CA 92707

**DSA ADDENDUM NO: 01 & 02** 

DATE: 06.10.2024

# **REVISION:**

Note: The following revisions and clarifications to the Contract Documents (plans) shall become a part of the Contract Documents. All bidders are required to incorporate all necessary changes, additions, or deductions into their proposals.

# **DSA ADDENDUM NO. 01**

# 1. CIVIL

- A. CD-1.0, Site Demolition Plan: Revised removal note #11, to now state: "remove and salvage existing camera and light pole and demolish its foundation in its entirety. Reinstall existing camera and light pole onto new foundation after construction of new curb median."
- B. CD-1.0, Site Demolition Plan: Revised removal note #12, to now state: "remove, salvage, and relocate existing exterior cane detection rails. Reinstall and attach cane detection rails at its original location per architectural drawings."
- C. CD-1.0, Site Demolition Plan: Added removal note #26 on the site plan adjacent to Building "H" to indicate: "remove, salvage and reinstall existing ADA door opener bollard with push plate and its conduit. Reinstall door opener bollard at its original location and adjust to new pavement grade as necessary."
- D. CD-1.0, Site Demolition Plan: Revised protect-in-place note #42, to now indicate: "protect in place existing electrical vault." Added the protect-in-place note #42 on the site plan near and below to Building "X".

# Santa Ana College Campus Entrance Improvements

DSA Addendum 1 & 2 – Statement of Revisions and Clarifications 06/10/2024

Page 2

E. CD-1.0, Site Demolition Plan: Removed protect-in-place note #59 in its entirety, (protect in place existing electrical vault).

# 2. ARCHITECTURAL

- A. A-11.1, Enlarged Improvements Site Plan: Added keynote #505, to indicate: "reinstall salvaged existing exterior cane detection guide rail on each side of door at its original location attach to (e) wall and (n) finish pavement. Refer to detail 3/A-11.1 for anchoring info." Added the keynote #505 on the site plan adjacent to Building "H" on the East.
- B. A-11.1, Enlarged Improvements Site Plan: Added detail 3 on the left side of the sheet, to provide information on anchoring the existing exterior cane detection guide rail that will need to be reused.
- C. A-11.1, Enlarged Improvements Site Plan: Added keynote #1001, to indicate: "reinstall and attach existing ADA door opener bollard at its original location and adjust to new pavement grades reconnect to existing electrical conduit. Refer to detail 2/A-11.1 for required height installation info." Added the keynote #1001 on the site plan adjacent to Building "H" on the East.
- D. A-11.1, Enlarged Improvements Site Plan: Added detail 2 on the left side of the sheet, per DSA's request to illustrate the required height of the bollard.
- E. A-11.1, Enlarged Improvements Site Plan: Added keynote #2603, to indicate: "reinstall and mount existing camera and pole onto new concrete foundation refer to electrical drawings for mounting and new concrete foundation base detail." Added the keynote #2603 on site plan within the new center median at the drive aisle, including located the camera pole's concrete base.

# 3. LANDSCAPE

- A. L-2.1, Landscape Construction Details: Revised note #2 in detail 4/L-2.1 to indicate the total number tiles at each concrete low wall, (12 low walls 24 tiles total).
- B. L-2.2, Landscape Construction Details: Revised note #1 in detail 2/L-2.2 to indicate: "install (6) Classics round open top receptacle (51 gallon) by Rubbermaid. Model #FGS55ETBKPL. Finish: Perforated Meal. Color: Textured Black. Secure receptacles to concrete paving with 1/2" X 3-3/4" zinc plated wedge anchors with a 3" X 3" sq. zinc plated steel washer on the inside of the receptacle (4 per receptacle). Install per manufacturer's recommendations and specifications. See landscape construction plan, sheet L-1.0 for locations."
- C. L-2.2, Landscape Construction Details: Removed the reference cut sheet of the 63-gallon waste receptacle and updated a new for the 51-gallon, model #FGS55ETBKPL

# Santa Ana College Campus Entrance Improvements

DSA Addendum 1 & 2 – Statement of Revisions and Clarifications 06/10/2024 Page 3

by Rubbermaid.

- D. L-4.01, Irrigation Details: Updated the Landscape Architect stamp with a new one having a non-expired renewal date, per DSA's request.
- E. L-5.0, Planting Plan: Revised keynote #2 to update the overall thickness layer of the mulch to now indicate: "all shrubs areas to receive a 4" layer of mulch. See sheet L-6.0 for planting notes and details."
- F. L-6.0, Planting Details: Revised keynote #19 in detail 1/L-6.0 to update the overall thickness layer of the mulch to now indicate: "all landscape areas (excluding turf) shall be mulched with a 4" deep layer of mulch, per specifications, at the conclusion of planning operations."
- G. L-6.0, Planting Details: Revised keynote #4 in detail 5/L-6.0 to update the overall thickness of the shredded bark mulch to now indicate: "4-inch-deep shredded bark mulch around tree. See planting plans for mulch spread diameter."

# 4. ELECTRICAL

- A. E-1.2, Power and Lighting Plans: Revised reconstruction keynote #16, to provide referenced detail of a new concrete base: "Camera and pole to be removed and stored during construction of concrete walkway/median for protection. Footing to be removed, provide new footing during reinstallation. See detail 1/E1.3 for camera pole base detail." Located the concrete base for the pole and camera on the lighting plan, 1/E-1.2.
- B. E-1.3, Photometric Plans: Added new camera pole base detail 1/ E-1.3 on left side of sheet. The new concrete base detail to install the existing pole and camera will be in the new median at the drive aisle near the vehicular entrance / exist.

# Santa Ana College Campus Entrance Improvements

DSA Addendum 1 & 2 – Statement of Revisions and Clarifications 06/10/2024
Page 4

# DSA ADDENDUM NO. 02

# 1. ELECTRICAL

- A. E-1.2, Power and Lighting Plans: Revised reconstruction keynote #15, to now state: "Provide a separate neutral for circuit A-10." Added the keynote on the southwest corner of Building "M" of the lighting plan, 1/E-1.2.
- B. E-1.2, Power and Lighting Plans: Added new reconstruction keynote #21, to indicate: "See pull box on lighting plan." Added the keynote on the west side of Building "M" of the power plan, 2/E-1.2.
- C. E-1.2, Power and Lighting Plans: Added new reconstruction keynote #22, to indicate: "Combine all wiring for panel 'A'. into (1) 1" conduit. Combine all wiring for inverter and panel 'B' (see power plan) into (1) 1" conduit." Added the keynote on the west side of Building "M" of the lighting plan, 1/E-1.2.
- D. E-1.2, Power and Lighting Plans: Added new reconstruction keynote #23, to indicate: "Enter Building M on southeast corner, stub up into 8X6 surface mounted pull box and stub in above Building M, curb into building wall. Run conduit and wiring inside wall into ceiling space and route conduit and wiring back to Electrical Room. Provide framing and plaster to match existing exterior around exposed conduit to hide electrical conduit." Added the keynote on the west side of Building "M" of the lighting plan, 1/E-1.2.
- E. E-1.2, Power and Lighting Plans: Added a note to provide information on the type and size of the conduit running from the center median at the pick-up/drop-off area to the new pull box adjacent to Building "M". Added the note between the center media of the pick-up/drop-off area and Building "M" of the lighting plan, 1/E-1.2.
- F. E-1.2, Power and Lighting Plans: Relocated the location of keynote #20's leader, which is now pointing at the conduit between a light pole fixture and new pull box. The keynote is located west of Building "M" of the lighting plan, 1/E-1.2.
- G. E-1.2, Power and Lighting Plans: Relocated the location of the note on the type and size of the conduit of B-4, which is now pointing at the conduit on the west side of the new pull box. The keynote is located west of Building "M" of the power plan, 2/E-1.2.
- H. E-5.1, Electrical Details and Schedules: Revised and updated the panel 'B's' existing load information, including the total panel load on detail 9/E-5.1.
- I. E-5.1, Electrical Details and Schedules: Added new note #3 on the panel 'B' schedule to indicate: "Tapped into main lugs." Added the note on the panel 'B' schedule on detail 9/E-5.1.

ATTACHMENTS: CD-1.0, A-11.1, L-2.1, L-2.2, L-4.01, L-5.0, L-6.0, E-1.2, E-1.3, E-5.1



140

# APPLICATION FOR SUBMITTAL OF POST-APPROVAL DOCUMENT

This application is for submittal of documents, after the initial approval of the project (post-approval documents), that require Division of the State Architect (DSA) review and approval. This form shall be completed by the Design Professional in General Responsible Charge of the project, in accordance with California Code of Regulations, Title 24, Part 1, Sections 4-317, 4-323 and 4-338 and in compliance with DSA IR A-6: Construction Change Document Submittal and Approval Process.

DSA documents reference	ed within this form are available	on the <u>DSA Forms</u> or <u>DSA P</u>	<u>ublications</u> webpages.		
1. SUBMITTAL TYPE:	(Is this a resubmittal? Yes□	No □)			
Deferred Submittal □	Addendum Number:	Revision Number:	CCD Nu	mber:	Category A □ or B □
2. PROJECT INFORM	ATION:				
School District/Owner:				DSA File Nu	ımber:
Project Name/School:				DSA Applica	ation Number:
3. APPLICANT INFOR	MATION:				
Date Submitted:		Attached Pa	ges? No □ Yes □ Num	ber of pages?	
Firm Name:		Contact Nam	ne:		
Work Email:		Work Phone	:		
Firm Address:		City:		State:	Zip Code:
4. REASON FOR SUB	MITTAL: (Check applicable be	oxes)			
☐ For revision or adden	dum prior to construction.		☐ For a	project curren	tly under construction.
☐ For a project that has a 90-Day Letter issue		of Requirement for Certificat	ion, DSA 301-P: Poste	d Notification o	of Requirement for Certification or
☐ To obtain DSA appro	val of an existing uncertified bu	lding or buildings.			
☐ For Category B CCD	this is: □ a voluntary submittal,	☐ a DSA required submittal (	attach DSA notice requ	iring submissi	on).
5. DESIGN PROFESS	IONAL IN GENERAL RESPON	SIBLE CHARGE:			
Name of the Design Pro	ofessional In General Responsib	le Charge:			
Professional License Nu	ımber:	Discipline:			
and appear to meet the	appropriate requirements of Titl onstruction of the project.		ulations and the project		camined by me for design intent . They are acceptable for
6. CONFIRMATION D	ESCRIPTION AND LISTING O		- 0,,,,,,		
For addenda, revisions, Design Professional list Use of Construction Do	or CCDs: CHECK THIS BOX □ ed on form <i>DSA 1: Application f</i> cuments Prepared by Other Pro cable, for signature and seal red	to confirm that all post-approor Approval of Plans and Spe fessionals, and IR A-19: Desi	cifications for this proje	ct. (For <i>Deferr</i>	ed Submittals, refer to IR A-18:
Provide a brief descripti	on of construction scope for this	post-approval document (att	ach additional sheets if	needed):	
List of DSA-approved di	rawings affected by this post-ap	proval document:			
		DSA USE ONLY	/		
		DOA COL CINE	Returned		DSA STAMP
SSSD	ate □Approved □	Disapproved □Not Required	Date:		
Comments:			By:		
FLS D	rate	Disapproved □Not Required			
Comments:		- Interpreted - Interrequied			
Commonio.					
	ate □Approved □	Disapproved □Not Required			
Comments:				1	

# **REMOVAL LEGEND:**

REMOVE EXISTING 4" CONCRETE PAVEMENT WITH #3 REBAR @ 18" O.C. EACH WAY OVER 6" THICK BASE MATERIAL, FULL DEPTH.

REMOVE EXISTING 3" AC PAVEMENT OVER 9.5" THICK BASE MATERIAL, FULL DEPTH.

CLEAR, GRUB AND REMOVE EXISTING TURF/PLANTER/SHRUBS/EXPOSED SUBGRADE AREA. REMOVE EXISTING SHRUBS AND ROOTS IN THEIR ENTIRETY. REMOVE EXISTING IRRIGATION LATERALS AND HEADS PER LANDSCAPE DRAWINGS.

REMOVE EXISTING 3.50" THICK PAVERS OVER 1.5" SAND OVER EXISTING AC OR CC PAVEMENT SECTION OVER BASE MATERIAL, FULL DEPTH.

REMOVE EXISTING 7" CONCRETE PAVEMENT WITH #4 REBAR @ 12" O.C. EACH WAY OVER 6" THICK BASE MATERIAL, FULL DEPTH.

REMOVE EXISTING 7" PCC OVER 6" CLASS 2 CRUSHED AGGREGATE BASE WITH #3 REBAR @ 18" O.C. EACH WAY, FULL DEPTH.

REMOVE EXISTING RETAINING WALL IN ITS ENTIRETY.


— LIMIT OF REMOVAL

# SHEET NOTES:


57 PROTECT IN PLACE EXISTING TRAFFIC POLE AND BASE IN ITS

58 PROTECT IN PLACE EXISTING COMMUNICATION VAULT.

- FOR GENERAL NOTES, LEGENDS AND ABBREVIATIONS, SEE SHEET C-1.0.
- SEE ARCHITECTURAL DRAWINGS FOR OTHER SITE RELATED DIMENSIONS NOT SHOWN ON THIS DRAWING.
- IT SHALL BE THE RESPONSIBILITY OF THE CONTRACTOR TO VERIFY AND SURFACE AND/OR UNDERGROUND UTILITIES IN DESIGN TEAM PRIOR TO THE COMMENCEMENT OF WORK
- ELEVATION AND THE CURRENT SITE CONDITION WITH THE DESIGN GRADES. CONTRACTOR SHALL REPORT ANY DISCREPANCIES TO THE OWNER OR DESIGN TEAM PRIOR TO THE COMMENCEMENT OF WORK.
- FOR REMOVAL AND PROTECT IN PLACE OF ALL EXISTING UTILITIES, SEE SHEET CD-1.1.

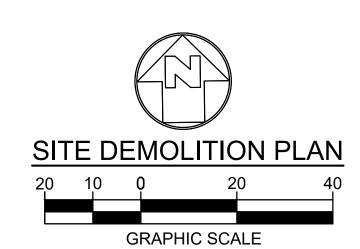

SCALE 1" - 20'

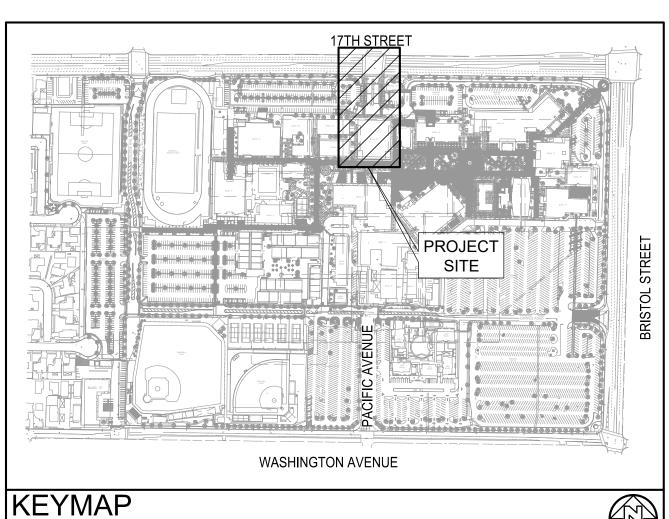

SCALE: NOT TO SCALE

THIS DOCUMENT CONTAINS INFORMATION PROPRIETARY TO SVA ARCHITECTS NC. AND IS FURNISHED IN CONFIDENCE FOR THE LIMITED PURPOSE OF VALUATION, BIDDING OR REVIEW, THIS DOCUMENT OR ITS CONTENTS MAY NOT BE USED FOR ANY OTHER PURPOSE AND MAY NOT BE REPRODUCED OR DISCLOSED TO OTHERS WITHOUT THE PRIOR WRITTEN CONSENT OF SVA ARCHITECTS INC. ALL RIGHTS RESERVED, © COPYRIGHT 2020.

ADDENDUM 1

DATE ISSUED: PROJECT NO:

DSA APPLICATION NO: 04-122485 SCALE:


SHEET **NUMBER:** 

2021-07-19

CD-1.0 SITE **DEMOLITION PLAN** 



6 HUTTON CENTRE DR, SUITE 1150 SANTA ANA, CA 92707 WWW.SVA-ARCHITECTS.COM T 949.809.3380

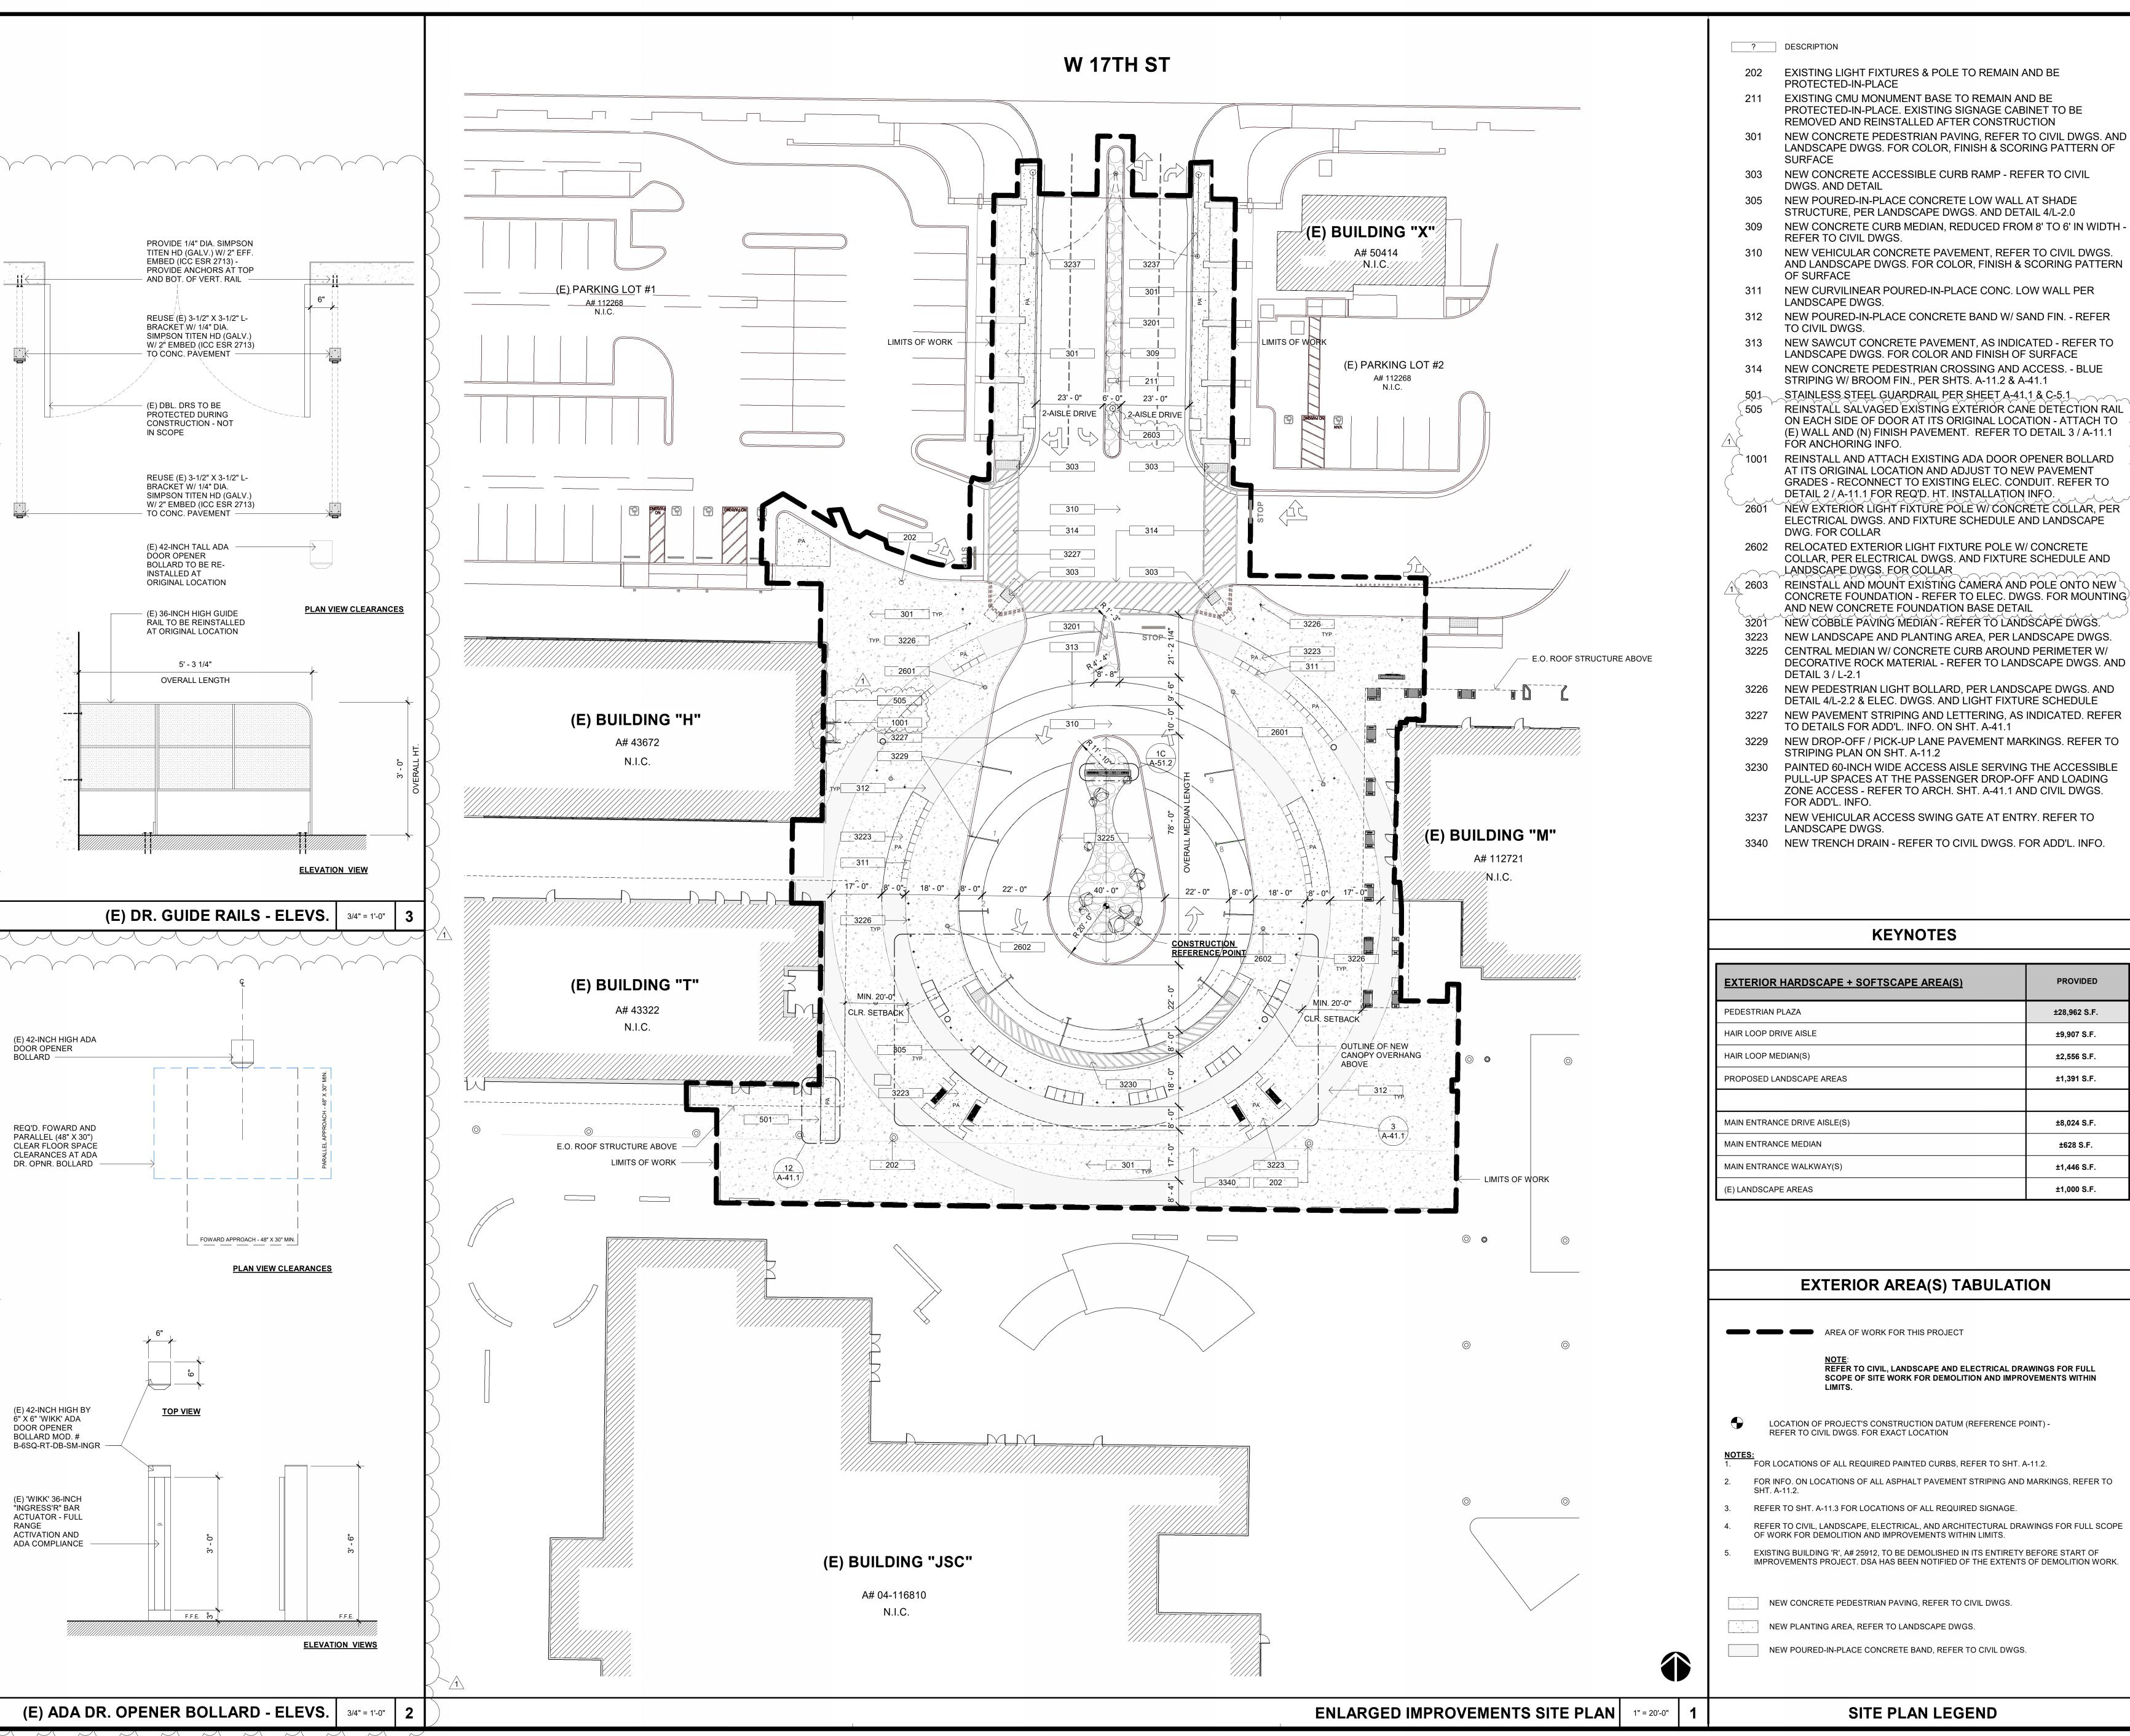

- EXISTING LIGHT FIXTURES & POLE TO REMAIN AND BE
  - PROTECTED-IN-PLACE EXISTING CMU MONUMENT BASE TO REMAIN AND BE
  - PROTECTED-IN-PLACE. EXISTING SIGNAGE CABINET TO BE REMOVED AND REINSTALLED AFTER CONSTRUCTION
  - NEW CONCRETE PEDESTRIAN PAVING, REFER TO CIVIL DWGS. AND LANDSCAPE DWGS. FOR COLOR, FINISH & SCORING PATTERN OF
- NEW CONCRETE ACCESSIBLE CURB RAMP REFER TO CIVIL DWGS. AND DETAIL
- NEW POURED-IN-PLACE CONCRETE LOW WALL AT SHADE STRUCTURE, PER LANDSCAPE DWGS. AND DETAIL 4/L-2.0
- NEW CONCRETE CURB MEDIAN, REDUCED FROM 8' TO 6' IN WIDTH -REFER TO CIVIL DWGS.
- NEW VEHICULAR CONCRETE PAVEMENT, REFER TO CIVIL DWGS. AND LANDSCAPE DWGS. FOR COLOR, FINISH & SCORING PATTERN
- NEW CURVILINEAR POURED-IN-PLACE CONC. LOW WALL PER
- NEW POURED-IN-PLACE CONCRETE BAND W/ SAND FIN. REFER TO CIVIL DWGS.
- NEW SAWCUT CONCRETE PAVEMENT, AS INDICATED REFER TO
- LANDSCAPE DWGS. FOR COLOR AND FINISH OF SURFACE
- NEW CONCRETE PEDESTRIAN CROSSING AND ACCESS. BLUE STRIPING W/ BROOM FIN., PER SHTS. A-11.2 & A-41.1
- STAINLESS STEEL GUARDRAIL PER SHEET A-41,1 & C-5.1 REINSTALL SALVAGED EXISTING EXTERIOR CANE DETECTION RAIL ON EACH SIDE OF DOOR AT ITS ORIGINAL LOCATION - ATTACH TO (E) WALL AND (N) FINISH PAVEMENT. REFER TO DETAIL 3 / A-11.1
- REINSTALL AND ATTACH EXISTING ADA DOOR OPENER BOLLARD AT ITS ORIGINAL LOCATION AND ADJUST TO NEW PAVEMENT GRADES - RECONNECT TO EXISTING ELEC. CONDUIT. REFER TO
- DETAIL 2 / A-11.1 FOR REQ'D. HT. INSTALLATION INFO. NEW EXTERIOR LIGHT FIXTURE POLE W/ CONCRETE COLLAR, PER ELECTRICAL DWGS. AND FIXTURE SCHEDULE AND LANDSCAPE
- RELOCATED EXTERIOR LIGHT FIXTURE POLE W/ CONCRETE COLLAR, PER ELECTRICAL DWGS. AND FIXTURE SCHEDULE AND
- LANDSCAPE DWGS. FOR COLLAR REINSTALL AND MOUNT EXISTING CAMERA AND POLE ONTO NEW
- CONCRETE FOUNDATION REFER TO ELEC. DWGS. FOR MOUNTING AND NEW CONCRETE FOUNDATION BASE DETAIL
- NEW COBBLE PAVING MEDIAN REFER TO LANDSCAPE DWGS. NEW LANDSCAPE AND PLANTING AREA, PER LANDSCAPE DWGS. CENTRAL MEDIAN W/ CONCRETE CURB AROUND PERIMETER W/
- 3226 NEW PEDESTRIAN LIGHT BOLLARD, PER LANDSCAPE DWGS. AND
- DETAIL 4/L-2.2 & ELEC. DWGS. AND LIGHT FIXTURE SCHEDULE NEW PAVEMENT STRIPING AND LETTERING, AS INDICATED. REFER
- TO DETAILS FOR ADD'L. INFO. ON SHT. A-41.1 NEW DROP-OFF / PICK-UP LANE PAVEMENT MARKINGS. REFER TO STRIPING PLAN ON SHT. A-11.2
- PAINTED 60-INCH WIDE ACCESS AISLE SERVING THE ACCESSIBLE ZONE ACCESS - REFER TO ARCH. SHT. A-41.1 AND CIVIL DWGS. FOR ADD'L. INFO.
- 3237 NEW VEHICULAR ACCESS SWING GATE AT ENTRY. REFER TO LANDSCAPE DWGS.
- NEW TRENCH DRAIN REFER TO CIVIL DWGS. FOR ADD'L. INFO.

# **KEYNOTES**

EXTERIOR HARDSCAPE + SOFTSCAPE AREA(S)	PROVIDED
PEDESTRIAN PLAZA	±28,962 S.F.
HAIR LOOP DRIVE AISLE	±9,907 S.F.
HAIR LOOP MEDIAN(S)	±2,556 S.F.
PROPOSED LANDSCAPE AREAS	±1,391 S.F.
MAIN ENTRANCE DRIVE AISLE(S)	±8,024 S.F.
MAIN ENTRANCE MEDIAN	±628 S.F.
MAIN ENTRANCE WALKWAY(S)	±1,446 S.F.
(E) LANDSCAPE AREAS	±1,000 S.F.

# **EXTERIOR AREA(S) TABULATION**

AREA OF WORK FOR THIS PROJECT

NOTE:
REFER TO CIVIL, LANDSCAPE AND ELECTRICAL DRAWINGS FOR FULL
SCOPE OF SITE WORK FOR DEMOLITION AND IMPROVEMENTS WITHIN

LOCATION OF PROJECT'S CONSTRUCTION DATUM (REFERENCE POINT) - REFER TO CIVIL DWGS. FOR EXACT LOCATION

FOR LOCATIONS OF ALL REQUIRED PAINTED CURBS, REFER TO SHT. A-11.2. FOR INFO. ON LOCATIONS OF ALL ASPHALT PAVEMENT STRIPING AND MARKINGS, REFER TO

- REFER TO SHT. A-11.3 FOR LOCATIONS OF ALL REQUIRED SIGNAGE.
- REFER TO CIVIL, LANDSCAPE, ELECTRICAL, AND ARCHITECTURAL DRAWINGS FOR FULL SCOPE
- EXISTING BUILDING 'R', A# 25912, TO BE DEMOLISHED IN ITS ENTIRETY BEFORE START OF IMPROVEMENTS PROJECT. DSA HAS BEEN NOTIFIED OF THE EXTENTS OF DEMOLITION WORK.

NEW CONCRETE PEDESTRIAN PAVING, REFER TO CIVIL DWGS.

NEW POURED-IN-PLACE CONCRETE BAND, REFER TO CIVIL DWGS.

SITE PLAN LEGEND

O & <u>⊢</u>

REVISIONS:

C

KEV	ISIONS:	
	DESCRIPTION	DATE
1	ADDENDUM 1	5/3/20
$\triangle$		
$\triangle$		
$\triangle$		

2021-07-19 **DATE ISSUED:** PROJECT NO: 2020-40160 **DSA APPLICATION NO:** 04-122485 **SCALE:** As indicated


SHEET A-11.1 NUMBER: SHEET TITLE:

**ENLARGED IMPROVEMENTS** SITE PLAN



6 HUTTON CENTRE DR, SUITE 1150 SANTA ANA, CA 92707 T 949.809.3380 WWW.SVA-ARCHITECTS.COM

THIS DOCUMENT CONTAINS INFORMATION PROPRIETARY TO SVA ARCHITECTS NC. AND IS FURNISHED IN CONFIDENCE FOR THE LIMITED PURPOSE OF NOT BE USED FOR ANY OTHER PURPOSE AND MAY NOT BE REPRODUCED OR DISCLOSED TO OTHERS WITHOUT THE PRIOR WRITTEN CONSENT OF SVA ARCHITECTS INC. ALL RIGHTS RESERVED, © COPYRIGHT 2020.

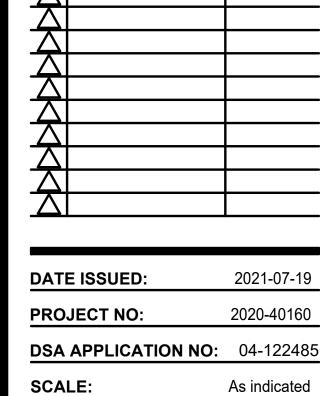

**REVISIONS:** 


1 ADDENDUM 1

NUMBER: SHEET TITLE: LANDSCAPE



L-2.1



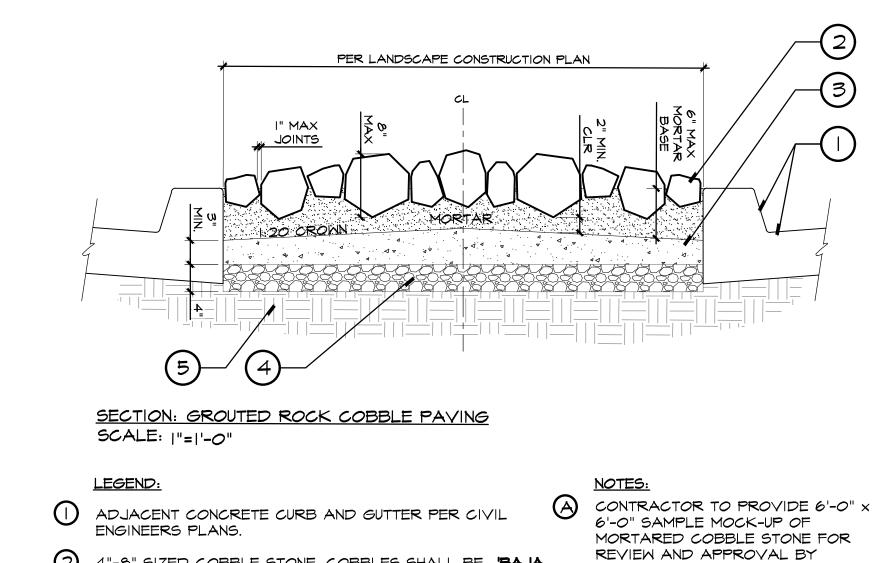

2 4"-8" SIZED COBBLE STONE. COBBLES SHALL BE BAJA CRESTA RUBBLE', AVAILABLE FROM: SOUTHWEST BOULDER AND STONE, OR APPROVED EQUAL. CONTACT BE IMBEDDED 50% MIN. INTO MORTAR BASE. MORTAR COLOR: TRUTONE COLOR 51127 'TAN'. MORTAR JOINTS SHALL BE RAKED. QUANTITY PER 'COBBLE / GRAVEL' SCHEDULE. SEE DETAIL 3, THIS SHEET.

3 3" MIN. THICK, CONCRETE PAD TO RECEIVE MORTAR AND COBBLE. PROVIDE CONTINUOUS 1:20 CROWN FROM

GEOTECHNICAL REPORT.

SUBGRADE PER GEOTECHNICAL REPORT.

PAVING EDGES TO CENTER OF FIELD.

# KRISTINE ALBINO (760) 451-3333 EXT. 1030. COBBLE TO B CONTRACTOR SHALL RAKE & CLEAN BE IMPEDDED 50% MIN INTO MORTAR BASE MORTAR BETWEEN COBBLE SHALL BE I" MAX IN SIZE. ALL JOINTS

4" CRUSHED AGGREGATE BASE (CAB) PER


5 90% MINIMUM COMPACTED, MOISTURE-CONDITIONED

# LANDSCAPE ARCHITECT AND

PERMITTED.

DISTRICT PRIOR TO INSTALLATION. JOINTS BETWEEN COBBLE TO REMOVE ANY EXCESS GROUT VISIBLE GROUT EXCESS NOT

# GROUTED ROCK COBBLE PAVING

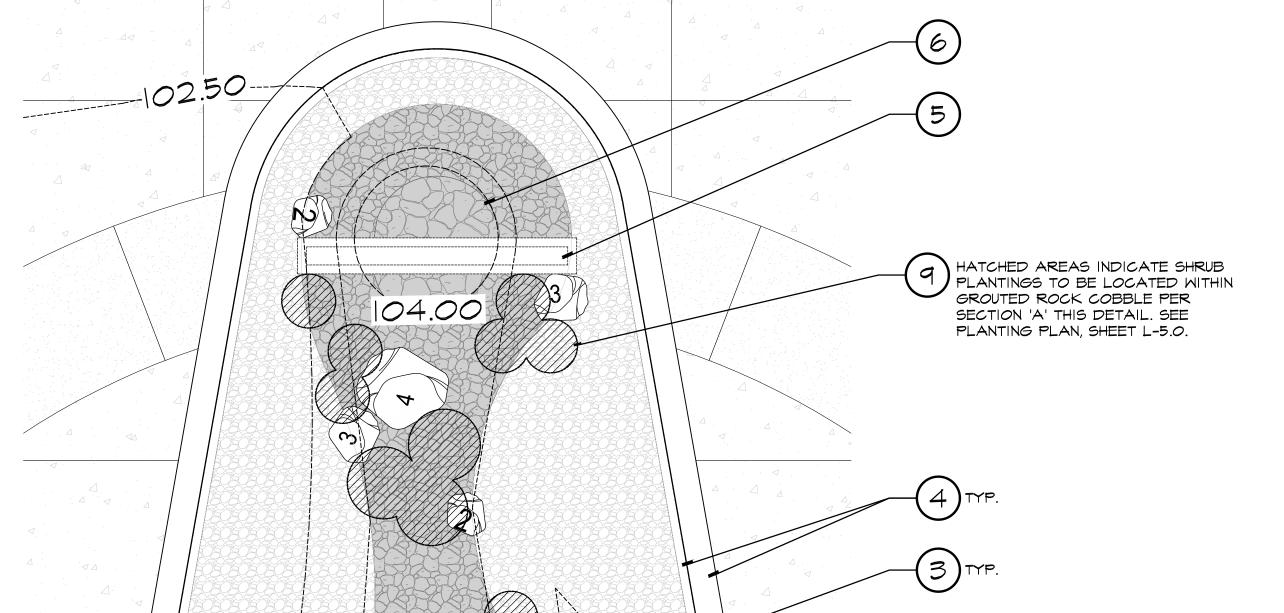

DIAMETER PER BOULDER SCHEDULE

A SEE CONSTRUCTION PLAN, SHEET L-1.0 AND ENLARGEMENT THIS SHEET FOR BOULDER LOCATIONS. PLAN LOCATIONS ARE

BOULDER HEIGHT NOT TO EXCEED 3'-O" AS TO NOT RESTRICT

BOULDERS SHALL BE PLACED/POSITIONED IN TIGHT

REPRESENT NATURAL BOULDER OUTCROPPINGS.

PROXIMITY TO ADJACENT BOULDERS IN ORDER TO

B ALL BOULDERS TO HAVE 1/3 EMBEDMENT.

VEHICULAR SIGHT LINES.

DIAGRAMMATIC. FINAL BOULDER PLACEMENT & INSTALLATION

SHALL BE UNDER THE DIRECTION OF LANDSCAPE ARCHITECT.

DIAMETER PER BOULDER SCHEDULE

BOULDERS SHALL BE 'BAJA CRESTA RED', AVAILABLE

90% MINIMUM COMPACTED, MOISTURE CONDITIONED

3 4" CONCRETE SUB-BASE. SUB-BASE TO EXTEND TO LIMIT

BOULDERS IN CONTACT WITH ADJACENT CONCRETE

COBBLE PAVING, WHERE OCCURS. SEE CONSTRUCTION

PLAN ENLARGEMENT SCALE: 3/16" = 1'-0"

4 ADJACENT MONUMENT SIGN FOOTING OR MORTARED

2 LANDSCAPE BOULDERS

OF BOULDER EDGE. CONCRETE BASE TO OCCUR AT ALL

SUBGRADE PER GEOTECHNICAL REPORT.

PAVING. SEE CONSTRUCTION PLAN.

PLAN, SHEET L-1.0 FOR LOCATIONS.

5 FINISH GRADE. SEE CIVIL PLANS.


DETAIL 3, THIS SHEET.

FROM: **SOUTHWEST BOULDER AND STONE,** OR APPROVED

1030. SIZE & QUANTITY PER 'BOULDER SCHEDULE'. SEE

EQUAL. CONTACT: KRISTINE ALBINO (760) 451-3333 EXT.

- LANDSCAPE BOULDERS. SEE DETAIL 2, THIS SHEET AND 'BOULDER SCHEDULE' THIS DETAIL.
- 2 COBBLE. SEE 'COBBLE/GRAVEL SCHEDULE' THIS DETAIL. A 4"-8" LARGE COBBLE - GROUTED, SINGLE COURSE TYP.
- 4) CONCRETE CURB AND GUTTER. SEE CIVIL PLANS. (5) CAMPUS MONUMENT SIGN. LOCATION SHOWN FOR REFERENCE
- 6 LANDSCAPE MOUNDING PER CIVIL PLANS. LANDSCAPE AREA SHALL RECEIVE ADDITIONAL TOP SOIL TO CREATE A MOUNDING EFFECT.
- MORTAR SETTING BED TO RECEIVE COBBLES. DIMENSIONS PER SECTION 'A', THIS DETAIL. THICKENED EDGE WITH I/2" RADIUS ADJACENT TO SHRUB PLANTING AREAS. COLOR: TRUTONE COLOR 51127 'TAN'. MORTAR JOINTS BETWEEN COBBLE SHALL BE I" MAX IN SIZE. ALL JOINTS SHALL BE RAKED.
- MIRAFI 140N GEOTEXTILE / WEED BARRIER TO BE INSTALLED BENEATH NON-GROUTED GRAVEL. INSTALL PER
- PLANTING PLAN, SHEET L-5.0

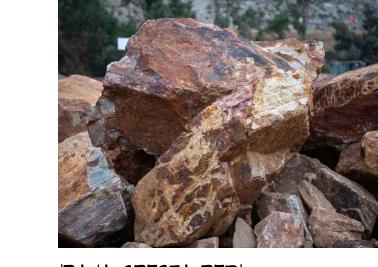

	BOULDER SCHEDULE							
SIZE	#2 2'Lx2'Wx2'D	#3 3'Lx3'Wx3'D	#4 4'L×4'W×3'D	#5 5'Lx5'Mx3'D				
QUANTITY	6	6	4	I				
SYMBOL	<b>©</b>	3	4	5				

BOULDERS SHALL BE 'BAJA CRESTA RED', AVAILABLE FROM: SOUTHWEST BOULDER AND STONE, OR APPROVED EQUAL. CONTACT: KRISTINE ALBINO (760) 451-3333 EXT. 1030.

COBBLE / GRAVEL SCHEDULE

GROUTED GROUTED NON-GROUTED SINGLE-COURSE SINGLE-COURSE 4" LAYER

COBBLES SHALL BE 'BAJA CRESTA RUBBLE', AVAILABLE FROM: SOUTHWEST

BOULDER AND STONE, OR APPROVED

EQUAL. CONTACT: KRISTINE ALBINO

GRAVEL SHALL BE MOJAVE GOLD CRUSHED STONE', AVAILABLE FROM:

ALBINO (760) 451-3333 EXT. 1030.

SOUTHWEST BOULDER AND STONE, OR

APPROVED EQUAL. CONTACT: KRISTINE

(760) 451-3333 EXT. 1030.

GRAVEL 3/4"



QUANTITY

B I"-3" SMALL COBBLE - GROUTED, SINGLE COURSE TYP.

3 4" LAYER OF 3/4" GRAVEL (NON-GROUTED). SEE 'COBBLE/GRAVEL SCHEDULE' THIS DETAIL.

ONLY. SEE ARCHITECTURAL PLANS AND DETAILS.

MANUFACTURER'S SPECIFICATIONS.

 LANDSCAPE SHRUB PLANTING TO BE LOCATED WITHIN GROUTED ROCK COBBLE. SEE SECTION 'A', THIS DETAIL AND

NOTE:
CONTRACTOR TO CHALK MARK BOULDER LOCATIONS FOR LANDSCAPE ARCHITECT REVIEW AND APPROVAL PRIOR TO INSTALLATION.

6" CLR. FROM BASE OF PLANT MATERIAL- TYP.  9  1	

FRONT ELEVATION: LOW WALL TILE DETAIL

SCALE: |"=|'-0"

2 8"X8"X2-1/4" GLAZED DECORATIVE TILE PAVER, MODEL #FDI59 BY MANUFACTURER CALIFORNIA POTTERY AND

4 DECORATIVE TILE AT ENDS OF CONCRETE LOW WALLS

CONTRACTOR SHALL SUBMIT SCALED SHOP DRAWINGS AND MATERIAL SUBMITTALS FOR REVIEW AND APPROVAL PRIOR TO CONSTRUCTION.

TILE WORKS. CONTACT DESMOND MCLEAN AT (323) 235-4151. TILE PAVERS ARE TO BE GROUTED IN PLACE AND INSTALLED TO BE FLUSH AT THE ENDS OF EACH CONCRETE LOW WALLS (12 LOW WALLS - 24 TILES TOTAL) PER

<u>SECTION A-A</u> SCALE: 3/8" = |'-0"

POURED-IN-PLACE CONCRETE LOW WALL PER DETAILS 3 \$ 4, SHEET L-2.0.

B PROVIDE MOCK UP FOR REVIEW AND APPROVAL PRIOR TO CONSTRUCTION.

CALIFORNIA POTTERY & TILE WORKS PAINTSHEET DATE: 9/28/23

. CP163

JOB NAME

**QUANTITY** 

DATE START FINISH # PCS.

FOR REFERENCE ONLY SCALE:N.T.S.

SCALE: |"=1'-0"


**FORMULA** 

SPECIAL INSTRUCTIONS


3 DECORATIVE ROCK MEDIAN ENLARGEMENT

**DETAILS** 

www.RJMdesigngroup.com [949] 493-2690 fax [949] 493-2600 phone

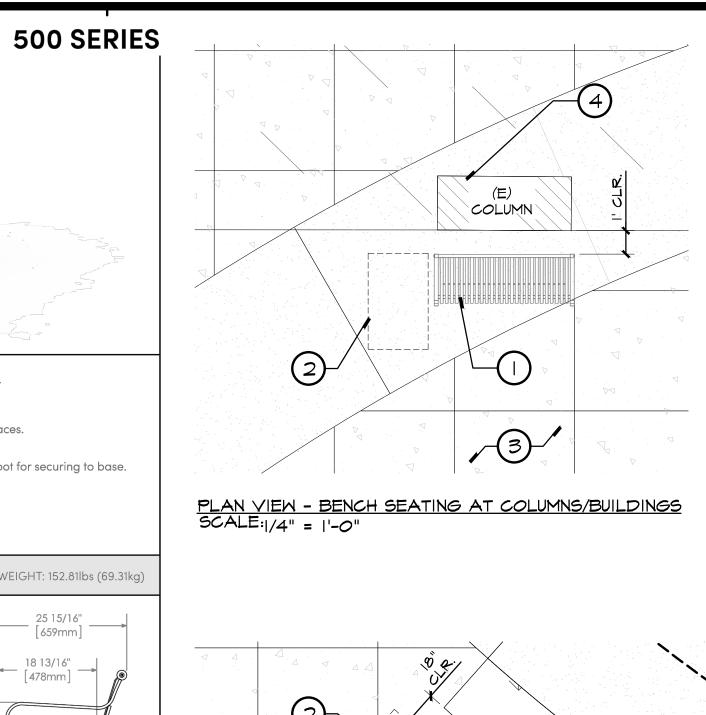




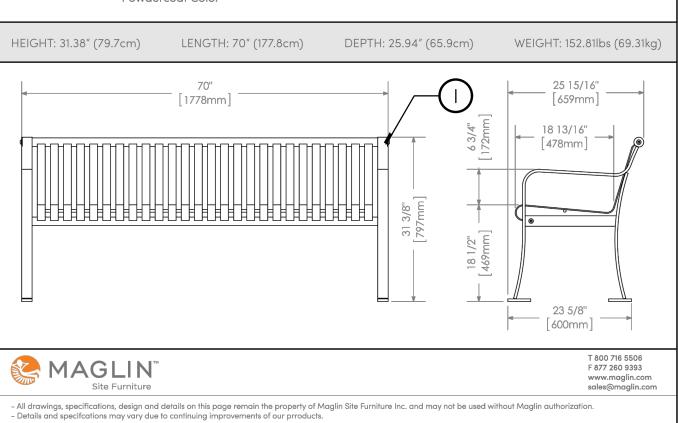

MBE-0510-00010


Legacy # MLB510-M


- (1) INSTALL (8) 'MODEL 510' 70" BACKED METAL BENCH BY MAGLIN SITE FURNITURE. MODEL #MBE-0510-00010. COLOR: BLACK (GLOSS COLLECTION). FINISH: POWDER COAT. SUPPLIED BY MAGLIN. CONTACT: SARAH MCKELLAR, (519) 539-6776. SURFACE MOUNT PER MANUFACTURER'S RECOMMENDATIONS. SEE LANDSCAPE CONSTRUCTION PLAN, SHEET L-1.0 FOR LOCATIONS.
- 4 EXISTING BUILDING COLUMNS, OR BUILDING WHERE OCCURS.

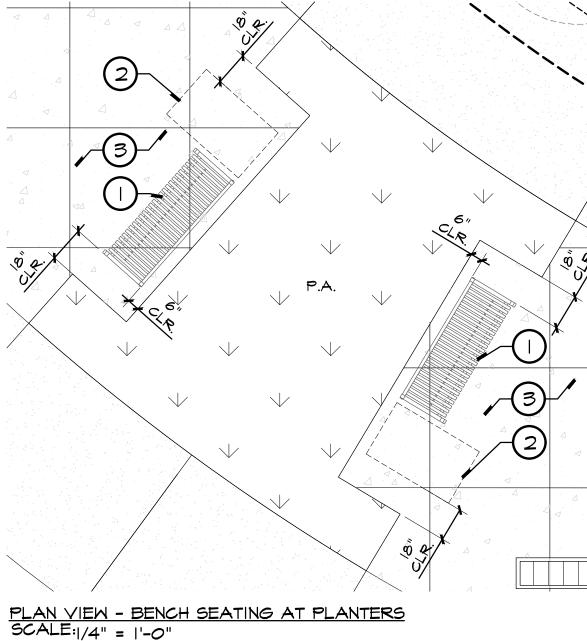


- 2) 36"X48" ADA COMPANION SEATING AREA. 3 ADJACENT CONCRETE PAVING. SEE LANDSCAPE CONSTRUCTION PLAN, SHEET L-I.O.

# BENCH SEATING AND ADA COMPANION SPACE

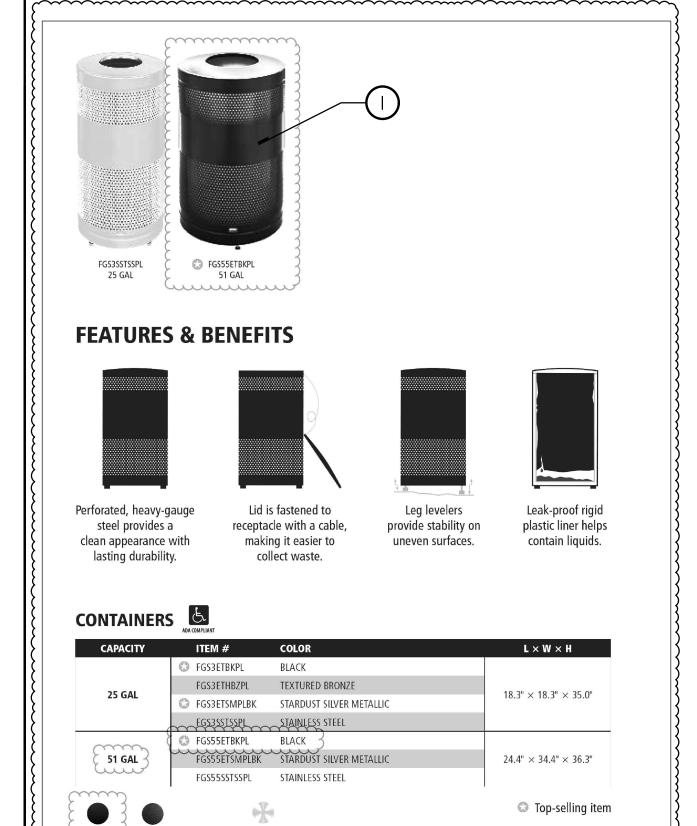

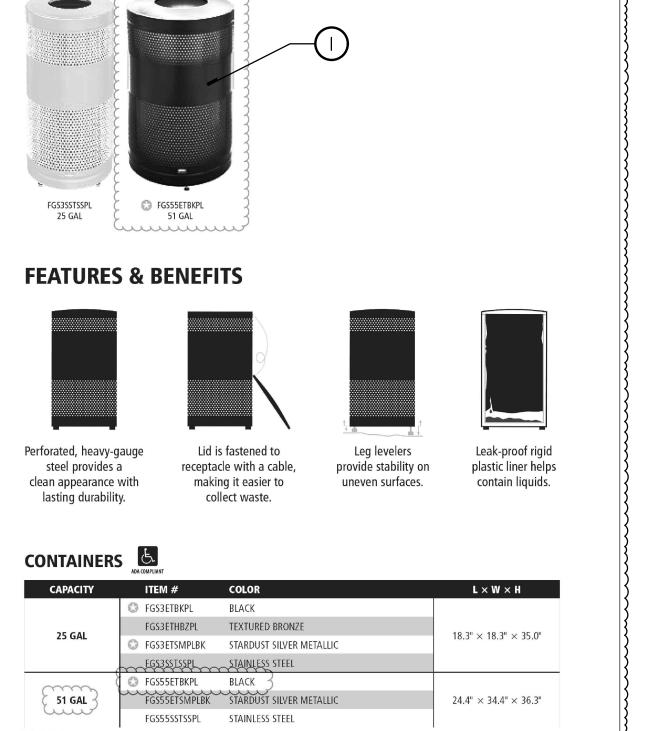


BLACK TEXTURED STARDUST STAINLESS
BRONZE SILVER STEEL
METALLIC 

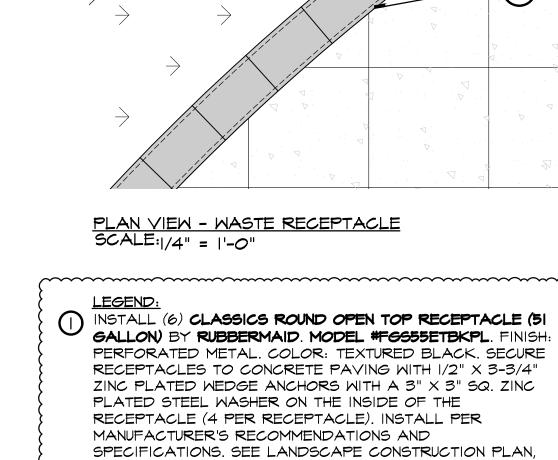

(2) CONCRETE LOW WALL. SEE CONSTRUCTION PLAN, SHEET L-1.0 FOR LOCATIONS. 3 ADJACENT CONCRETE PAVING. SEE CONSTRUCTION PLAN, SHEET L-1.0.

SHEET L-1.0 FOR LOCATIONS.

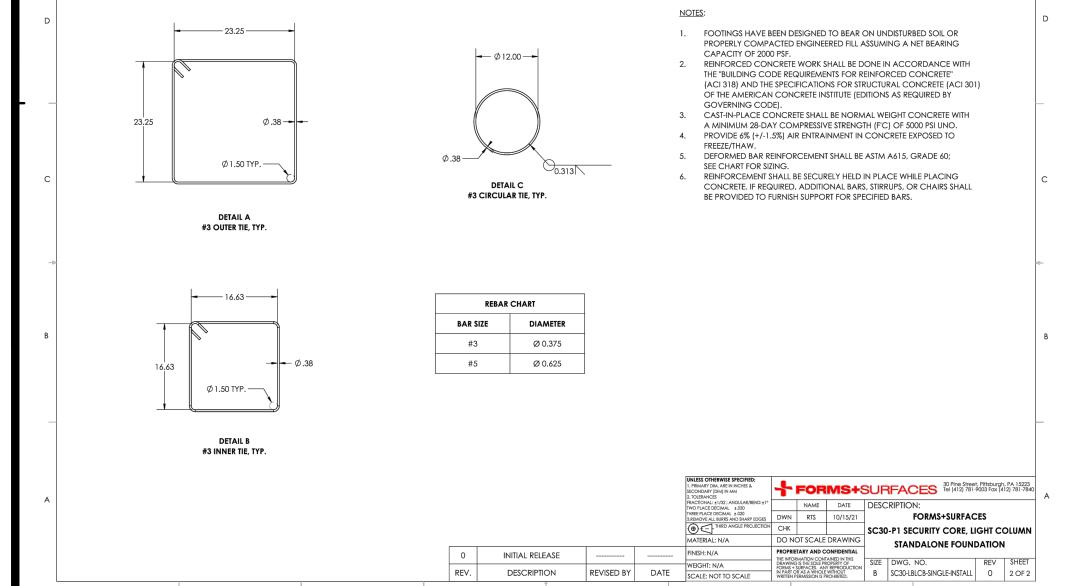

SIDE VIEW (PARTIAL SECTION)

DESCRIPTION

END VIEW (PARTIAL SECTION)

5 4 3 2

FORMS+SURFACES 30 Pine Street, Pittsburgh, PA 1522: Tel (412) 781-9003 Fax (412) 781-784

THE INFORMATION CONTAINED IN THIS DRAWING IS THE SOLE PROPERTY OF CONS. + SURFACE. A MY EXPOSULCTION IN PART OR & A WHOLE WITHOUT BE SOLE PROPERTY OF CONS. + SURFACE. ON \$4 PROJECT FOR SOLE PROPERTY OF CONS. + SURFACE. + SUR

PROPRIETARY AND CONFIDENTIAL

3.19 TYP. 3.63

PLAN VIEW (PARTIAL SECTION)

REVISED BY DATE SCALE: NOT TO SCALE

HE INFORMATION CONTAINED IN THIS DRAWNING ST HE SOLE PROPERTY OF WHITE SOLE P

FORMS+SURFACES 30 Pine Street, Pittsburgh, PA 15223 Tel (412) 781-9003 Fox (412) 781-7840

FORMS+SURFACES

SC30-P1 SECURITY CORE, LIGHT COLUMN

CUSTOM STANDALONE FOUNDATION

#3 CIRCULAR TIE, TYP.

#3 OUTER TIE, TYP.

(SEE DETAIL A, SH2)

4.00 TYP.

CUSTOM STANDALONE FOUNDATION

#3 INNER TIE, TYP.

LIGHT COLUMN #LBLCO-604

END VIEW

END VIEW (PARTIAL SECTION)

OF CONCRETE, TYP.

4.00 MAX PAVER LAYER 🕦

-#3 OUTER TIE, TYP. (SEE DETAIL A, SH2) #3 INNER TIE, TYP. (SEE DETAIL B, SH2)

PAVER LAYER-

ELEVATION SCALE: |" = |'-0" <u>PLAN</u> SCALE: |" = |'-0"

- INSTALL **LIGHT COLUMN BOLLARD**, **SERIES 600-6"** BY **FORMS AND** SURFACES. MODEL #LBLCO-604. FINISH: PERFORATED METAL. COLOR: ALUMINUM TEXTURE TO MATCH EXISTING. INSTALL WITH OPTIONAL EMBEDDED SECURITY CORE, MODEL #SC30-PI. SEE SHEET A-11.4 AND DETAIL I, SHEET E-1.2 FOR LOCATIONS. INSTALL PER MANUFACTURER'S RECOMMENDATIONS AND SPECIFICATIONS. SEE LANDSCAPE CONSTRUCTION PLAN, SHEET L-1.0 FOR LOCATIONS. CONTRACTOR TO CONFIRM EXISTING BOLLARD FINISH WITH MANUFACTURER.
- 2 CUSTOM STANDALONE FOUNDATION BY FORMS AND SURFACES. SEE MANUFACTURER'S DETAIL, THIS SHEET.
- 3 CONCRETE FOOTING PER MANUFACTURER'S DETAIL, THIS SHEET.
- 4 ELECTRICAL CONDUIT PER ELECTRICAL PLANS.

SCHEDULE, SHEET L-1.0.

MEDIUM BROOM FINISH. SEE LANDSCAPE CONSTRUCTION PLAN AND FINISH SCHEDULE, SHEET L-1.0 6 ADJACENT CONCRETE PAVING WITH SAND FINISH. SEE LANDSCAPE

CONSTRUCTION PLAN AND FINISH

5 ADJACENT CONCRETE PAVING WITH

EXPANSION JOINT PER DETAIL I, SHEET

CONDITIONED SUBGRADE PER


(3) DRAIN LINE AND 3/4" GRAVEL SUMP PER MANUFACTURER'S DETAIL, THIS 9 90% MINIMUM COMPACTED, MOISTURE

2 WASTE RECEPTACLE


3 LIGHT COLUMN BOLLARDS

FOR REFERENCE ONLY SCALE:N.T.S.


A DEEP ROOT TREE BUBBLERS

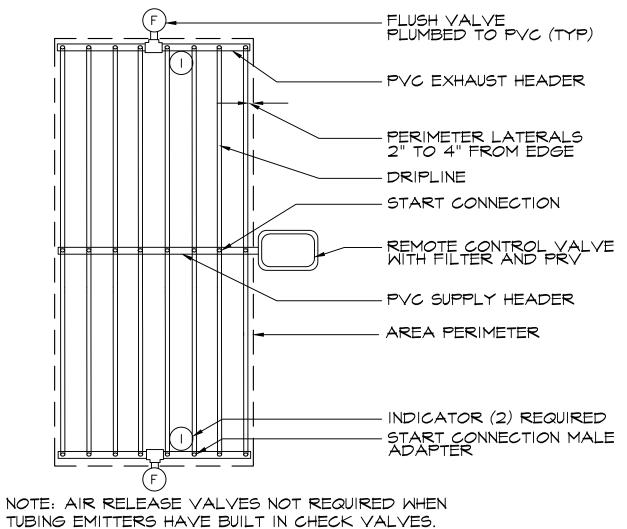


TUBING EMITTERS HAVE BUILT IN CHECK VALVES.

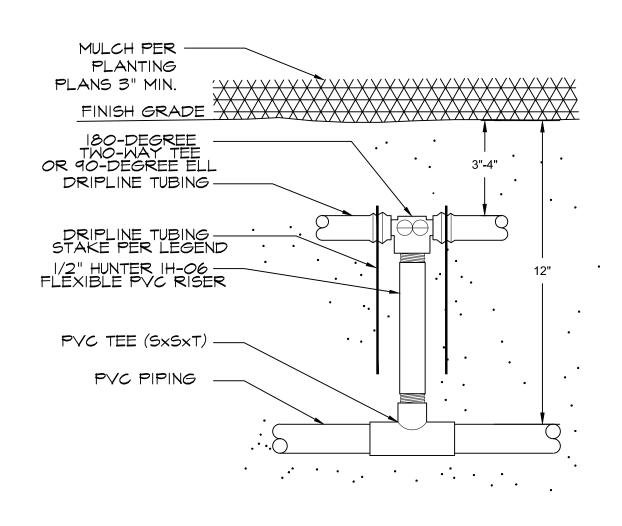


TUBING START CONNECTION

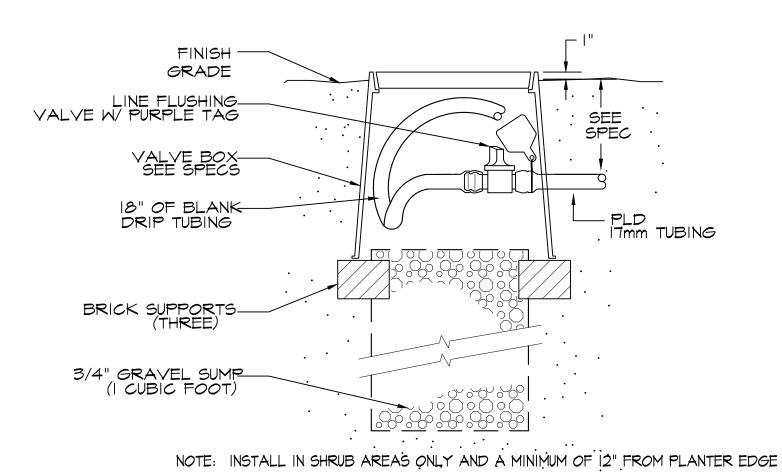

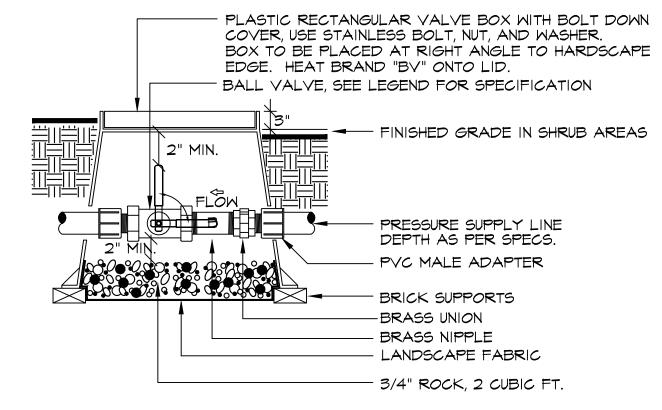


BOX TO BE INSTALLED AS TO ALLOW FOR PROPER OPERATION OF BALL VALVE INSTALL AT RIGHT ANGLE TO HARDSCAPE EDGE, INSTALL VALVE OFF-CENTER IN BOX. INSTALL VALVE BOX EXTENSIONS AS REQUIRED TO ACHIEVE PROPER VALVE INSTALLATION AT MAIN LINE DEPTH.

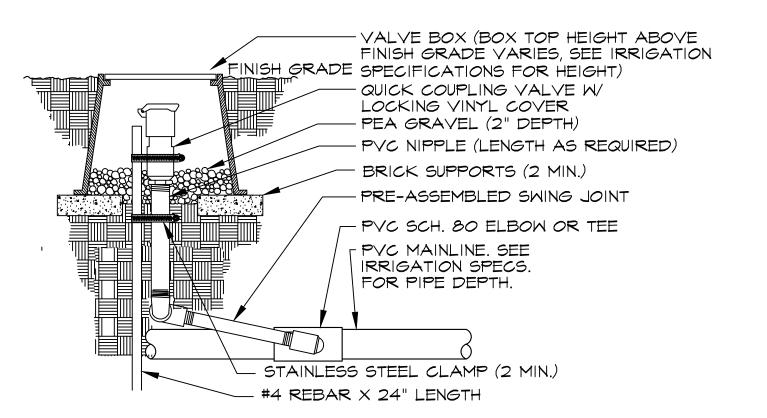

I. TEFLON TAPE ALL THREADS (TYP.) 2. INSTALL IN SHRUB AREAS ONLY AND A MINIMUM OF 12" FROM PLANTER EDGE



2) PVC MAINLINE

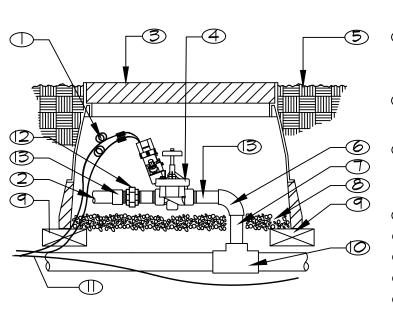

I. ALL WIRE TO BE INSTALLED

PER LOCAL CODES. 2. PROVIDE EXPANSION COILS AT EACH WIRE CONNECTION IN VALVE BOX. WRAP AROUND 1/2" PIPE 15 TIMES - REMOVE PIPE. 3. COMPACT SOIL AROUND VALVE BOX TO SAME DENSITY AS UNDISTURBED

ADJACENT SOIL. 4. INSTALL ONLY I VALVE PER VALVE BOX. 5. TEFLON TAPE ALL THREADS. 6. INSTALL IN SHRUB AREAS ONLY AND A MINIMUM OF 12" FROM PLANTER EDGE

── ○ EXPANSION CURLS WITH WATERPROOF WIRE CONNECTORS AT SPLICES (SEE IRRIGATION SPECS)


② PVC LATERAL TO SPRINKLERS ANGLE TO SPECIFIED DEPTH W/ 45 ELLS ③ VALVE BOX W/ LOCKING LID BOX HEIGHT ABOVE FINISH GRADE VARIES (SEE IRRIGATION SPECS)

4 REMOTE CONTROL VALVE (5) FINISH GRADE 6 SCH.80 PVC 90 SLIP X SLIP 7) PVC MAINLINE MATCH VALVE SIZE 2" LAYER OF PEA GRAVEL LEAVE I"-2" AIR SPACE

BETWEEN BOTTOM OF VALVE

AND TOP OF PEA GRAVEL 9 BRICK SUPPORT (I) AT EACH CORNER (O) PVC MAINLINE FITTINGS (2) LASCO SCH.80 UNION

(3) SCH.80 NIPPLE MIPT X SLIP MATCH VALVE SIZE

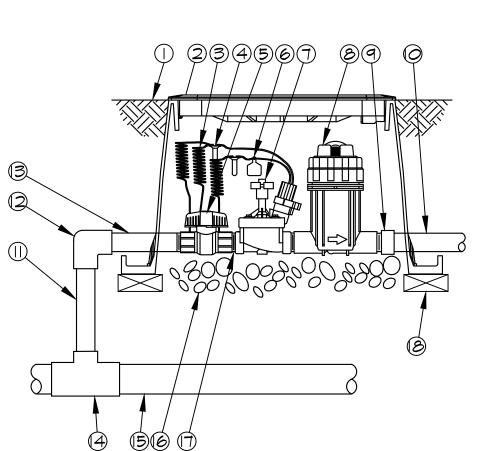


(I) FINISH GRADE/TOP OF MULCH 2) VALVE BOX WITH COVER 3 30-INCH LINEAR LENGTH OF WIRE, COILED (4) WATÉRPROOF CONNECTION: 5) I-INCH BALL VALVE 6 ID TAG

7) REMOTE CONTROL VALVE 8) PRESSURE REGULATING QUICK CHECK BASKET FILTER (9) LASCO PYC UNION

() LATERAL PIPE (II) PVC MAINLINE TO MATCH VALVE SIZE 2 PVC SCH 80 90DEG SLIP X SLIP 3 PVC SCH 80 NIPPLE MIPT X SLIP VALVE SIZE 4 PVC SCH 80 TEE OR ELL (5) MAINLINE PIPE


63-INCH MINIMUM DEPTH OF 3/4-INCH WASHED GRAVEL 17) PVC SCH 80 NIPPLE, CLOSE (8) BRICK SUPPORTS (4-REQUIRED)

NOTE: INSTALL IN SHRUB AREAS ONLY AND A MINIMUM OF 12" FROM PLANTER EDGE

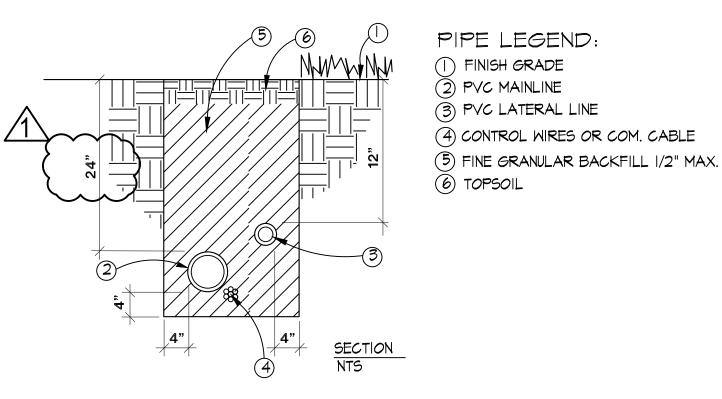


PIPE INSTALLATION NOTES: . TAPE AND BUNDLE 24 V. WIRES @ 10' INTERVALS. 2. MINIMUM DEPTH OF 24 V. WIRING SHALL BE 24" BELOW GRADE. 3. TRENCH WIDTH ALLOW 4" MIN. CLEARANCE BETWEEN PARALLEL PIPES. 4. SNAKE PIPES FROM SIDE TO SIDE WITHIN TRENCH TO ALLOW FOR MOVEMENT. 5. TIE A 20" LOOP IN ALL WIRING AT CHANGES OF DIRECTION. UNTIL PRIOR TO BACKFILLING TRENCHES. 6. PROVIDE THRUST BLOCKS PER APWA STANDARD PLANS FOR PUBLIC WORKS

CONSTRUCTION DETAILS

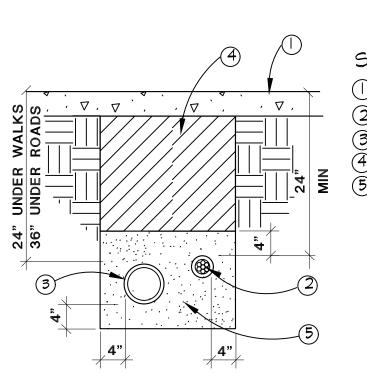

(1) PAVING (2) CONTROL WIRES OR COM. CABLE IN CONDUIT 3) SLEEVE FOR MAINLINE AND/OR LATERAL LINE (4) FINE GRANULAR BACKFILL 1/2" MAX. (5) SAND

SLEEVE NOTES: IRRIGATION PIPES UNDER ROADWAYS SHALL BE INSTALLED 36" DEEP, SLEEVED AND IDENTIFIED WITH MARKING TAPE INSTALLED 12" FROM THE SURFACE, IDENTIFYING TYPE OF LINE WITH APWA STANDARD "CAUTION WATERLINE BURIED BELOW" IN BLUE OR " CAUTION RECYCLED WATERLINE BURIED BELOW" IN PURPLE. SLEEVES SHALL BE SCHEDULE 40 PVC, TWO TIMES THE DIAMETER OF THE PIPE BEING SLEEVED.

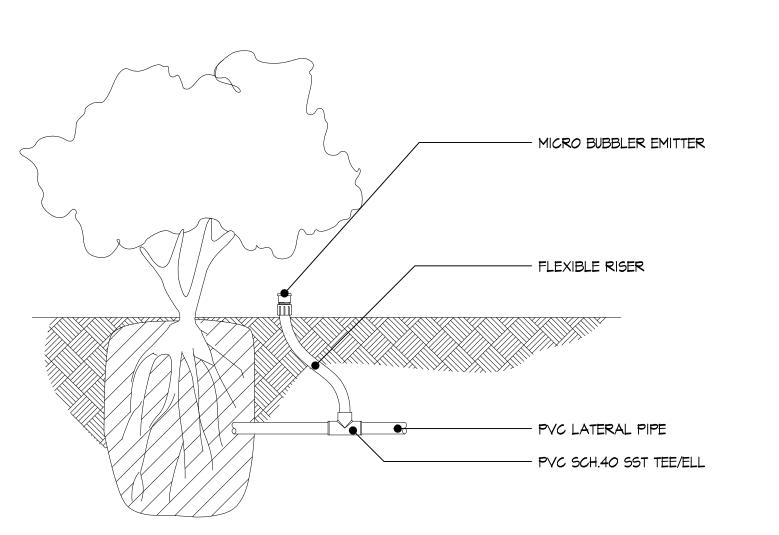


DRIP EMITTER ON FLEX RISER

CORROSIVE SOIL NOTE: PER THE SOILS REPORT, THE SITE DOES HAVE CORROSIVE SOIL AND THE CONTRACTOR SHALL ENSURE NO METAL IRRIGATION EQUIPMENT IS IN CONTACT WITH THE SOIL. ALL BRASS VALVES SHALL BE INSTALLED ABOVE GRAVEL, PER THE DETAILS, AND NOT BE IN CONTACT WITH THE SOIL. THE REBAR FOR THE QUICK COUPLER AND THE SOIL STAPLES FOR THE DRIPLINE SHALL BOTH HAVE PVC COATING.





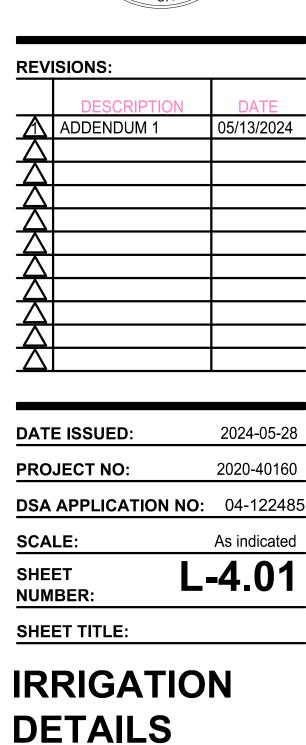

31591 Camino Capistrano

www.RJMdesigngroup.com

[949] 493-2690 fax


[949] 493-2600 phone

San Juan Capistrano, CA 92675

TRIC

DIS

# **DISTRIC**

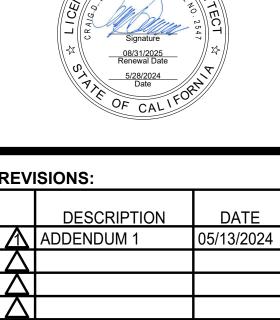

**REVISIONS:** ADDENDUM 1

2021-07-19 **DATE ISSUED:** PROJECT NO: 2020-40160 **DSA APPLICATION NO:** 04-122485 L-5.0

**NUMBER:** SHEET TITLE:

**PLAN** 

**PLANTING** 

31591 Camino Capistrano San Juan Capistrano, CA 92675 www.RJMdesigngroup.com

[949] 493-2690 fax [949] 493-2600 phone

0' 10' 20' UNDERGROUND SERVICE ALERT

TWO WORKING DAYS BEFORE YOU DIG

QTY.

218

180

TREE LEGEND BOTANICAL NAME SIZE REMARKS COMMON NAME DETAIL 5, SHEET L-6.0 PARKINSONIA X 'DESERT MUSEUM' DESERT MUSEUM PALO VERDE 48" BOX 25' H X 20' W PROTECT-IN-PLACE EXISTING TREES - TO REMAIN AS SHOWN

		SHRUB LEGEND		_
		BOTANICAL NAME COMMON NAME	SIZE	REMARKS
•	S-I	ANIGOZANTHOS 'BIG RED' RED KANGAROO PAW	5 GAL. @ 3'-0" O.C.	DETAILS 2#3, SHEET L-6.0
	S-2	MUHLENBERGIA RIGENS DEER GRASS	5 GAL. @ 3'-0" O.C.	DETAILS 2#3, SHEET L-6.0
*	5-3	PHORMIUM 'MAORI QUEEN' NEW ZEALAND FLAX	5 GAL. @ 3'-0" O.C.	DETAILS 2#3, SHEET L-6.0
	S-4	SALVIA LEUCANTHA MEXICAN BUSH SAGE	5 GAL. @ 4'-0" O.C.	DETAILS 2#3, SHEET L-6.0

# PLANT SYMBOL LEGEND

#	-TREE QUANTITY
T-I	TREE VARIETY
	•
#	-SHRUB QUANTITY
5-1	-SHRUB VARIETY

LOCATION OF AGRONOMIC SOIL TESTING ---- ROOT BARRIER

NOTE: SEE THE SPECIFICATIONS FOR DETAILED INFORMATION ON THESE ITEMS.

(E) BUILDING

22

32

5-3

WITTH ST.

LIMIT OF WORK

LIMIT OF WORK

NOTE: TREE ROOT BARRIERS TO BE PROVIDED AT ALL EXISTING

TREES WITHIN 10 FEET OF NEW CONCRETE FLATWORK - TYP.

(E) BUILDING "H"

(E) BUILDING

(E) P.A.

32 5-3


- PLANTING NOTES AND DETAILS.

  3. CONTRACTOR SHALL ESTABLISH A TREE PROTECTION ZONE (TPZ) FOR ALL EXISTING TREES WITHIN PROJECT LIMIT OF WORK AND THOSE IMMEDIATELY ADJACENT WITHIN 10'. 4. CONTRACTOR SHALL STAKE ALL FINAL LOCATIONS OF ALL PLANT MATERIAL FOR
- REVIEW AND APPROVAL FROM THE DISTRICT, PRIOR TO PLANTING. . PER PROJECT GEOTECH REPORT: WHERE NEW TREES OR LARGE LARGE SHRUBS ARE TO BE LOCATED IN CLOSE PROXIMITY OF NEW CONCRETE FLATWORK, RIGID MOISTURE / ROOT BARRIERS SHOULD BE PLACED AROUND THE PERIMETER OF THE FLATWORK TO AT LEAST 2 FEET IN DEPTH IN ORDER TO PROTECT THE FLATWORK FROM POTENTIAL ROOT AND MOISTURE DAMAGE. EXISTING MATURE TREES ADJACENT TO NEW FLATWORK SHOULD ALSO INCLUDE RIGID MOISTURE / ROOT BARRIERS PLACED AT LEAST 2 FEET IN DEPTH BELOW THE TOP OF THE FLATWORK.
- SEE PLANS AND SPECS FOR LOCATIONS. 6. CONTRACTOR TO PROVIDE ROOT BARRIERS AT EXISTING TREES WITHIN 10 FEET OF NEW CONCRETE FLATWORK.


# NOTICE TO CONTRACTOR

CONTRACTOR SHALL BE RESPONSIBLE FOR MAINTAINING PROTECTION OF ALL EXISTING SHRUB AND TURF AREAS TO REMAIN DURING CONSTRUCTION. DAMAGED SHRUB AND TURF AREAS SHALL BE REPAIRED OR REPLACED AT THE CONTRACTOR'S EXPENSE. TURF AREAS WITHIN EXISTING IRRIGATION RENOVATION/ RETROFIT ZONES AS INDICATED ON THE PROJECT IRRIGATION PLANS SHALL BE MAINTAINED AND REPAIRED IF NEEDED WITH NEW SOD.

> CORROSIVE SOIL NOTE:
> PER THE SOILS REPORT, THE SITE DOES HAVE CORROSIVE SOIL. SEE 'CORROSION POTENTIALS' AND ALL RELEVANT SECTIONS OF THE SOILS REPORT.

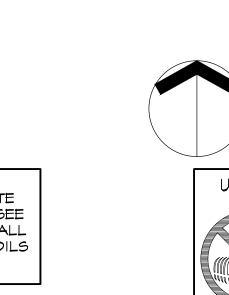

I PLANTING NOTES

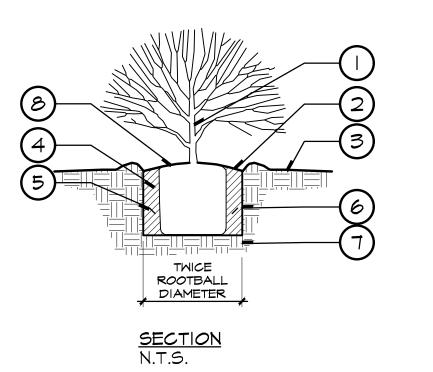

# EDGE OF PLANTING AREA SPACING

SECTION N.T.S.

3 GROUNDCOVER PLANTING

- O GROUNDCOVER FROM FLAT, CUTTING, LINER, OR PLANTING CONTAINER.
- 2 4" LAYER OF MULCH (DEPTH PER SPECIFICATIONS).
- 3 PLANTING BED DEPTH PER SPECIFICATIONS.

- (I) SHRUB CENTER IN PIT.
- 2" DEEP WATERING BASIN.
- 3 FINISH GRADE.
- 4 AMENDED BACKFILL REFER TO SPECIFICATIONS.
- 5 PLANTING TABLETS REFER TO SPECIFICATIONS FOR QUANTITY AND PLACEMENT.
- SCARIFY SIDES AND BOTTOM OF PLANTING PIT.
- (7) NATIVE UNDISTURBED SOIL
- SET TOP OF ROOTBALL 2" ABOVE SURROUNDING GRADE AND SLOPE FOR DRAINAGE.

2 SHRUB PLANTING

# ---- ROOTBALL ANCHORS TOP VIEW


- TREE CENTER IN PIT
- (2) DUCKBILL ROOTBALL ANCHOR KIT, SPECIFY "LARGE 88RBK KIT" TYPICAL OR APPROVED EQUAL. EACH KIT INCLUDES: (3) DUCKBILLS, (21 FT) 3/16" TENSION CABLE, (1) RATCHET TENSION STRAP.

SECTION VIEW

- INSTALL ROOTBALL ANCHOR KIT PER MANUFACTURER'S RECOMMENDATIONS. 4" DEEP SHREDDED BARK MULCH AROUND TREE. SEE PLANTING PLANS FOR MULCH SPREAD DIAMETER.
- (5) TIGHTLY COMPACTED 3" BERM TO FORM WATERING BASIN
- 6 FINISH GRADE
- (7) AMMENDED BACKFILL REFER TO SPECIFICATIONS
- NATIVE UNDISTURBED SOIL
- SET TOP OF ROOTBALL 2" ABOVE SURROUNDING GRADE AND SLOPE FOR DRAINAGE.

5 TREE PLANTING (36" BOX & LARGER)

(O) SCARIFY SIDES AND BOTTOM OF PLANTING PIT

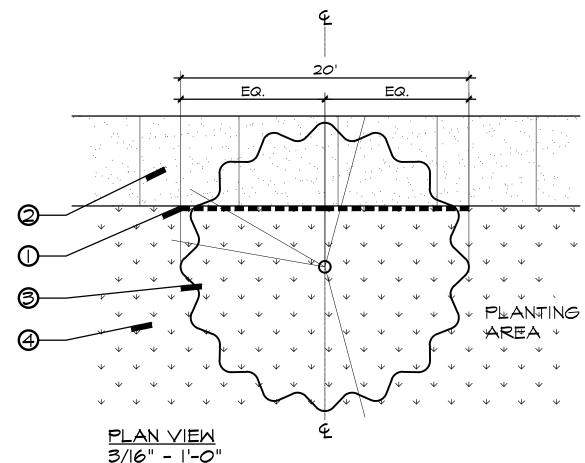

# <u>LEGEND</u>

- 2 ADJACENT HARDSCAPE. SEE CIVIL ENGINEER'S PLANS.
- (4) ADJACENT LANDSCAPE.

ALL TREES WITHIN 10' OF HARDSCAPE TO HAVE DEEP

- (1) DEEP ROOT BARRIER. ALL TREES PLANTED WITHIN 10' OF ANY HARDSCAPE ELEMENT (SIDEWALKS, WALLS, D.G., PAVERS, CURBS, ETC.) SHALL RECEIVE ROOT BARRIERS BY DEEP ROOT CORP. MODEL #UB 24-2. CONTACT INFO: (415) 781-9700. INSTALL PANELS PER MANUFACTURER'S

- RECOMMENDATIONS. SEE SPECIFICATIONS.


4 ROOT BARRIER

**REVISIONS:** 1 ADDENDUM 1

2021-07-19 **DATE ISSUED: PROJECT NO:** 2020-40160 DSA APPLICATION NO: 04-122485 L-6.0 **NUMBER:** 


SHEET TITLE: **PLANTING DETAILS** 



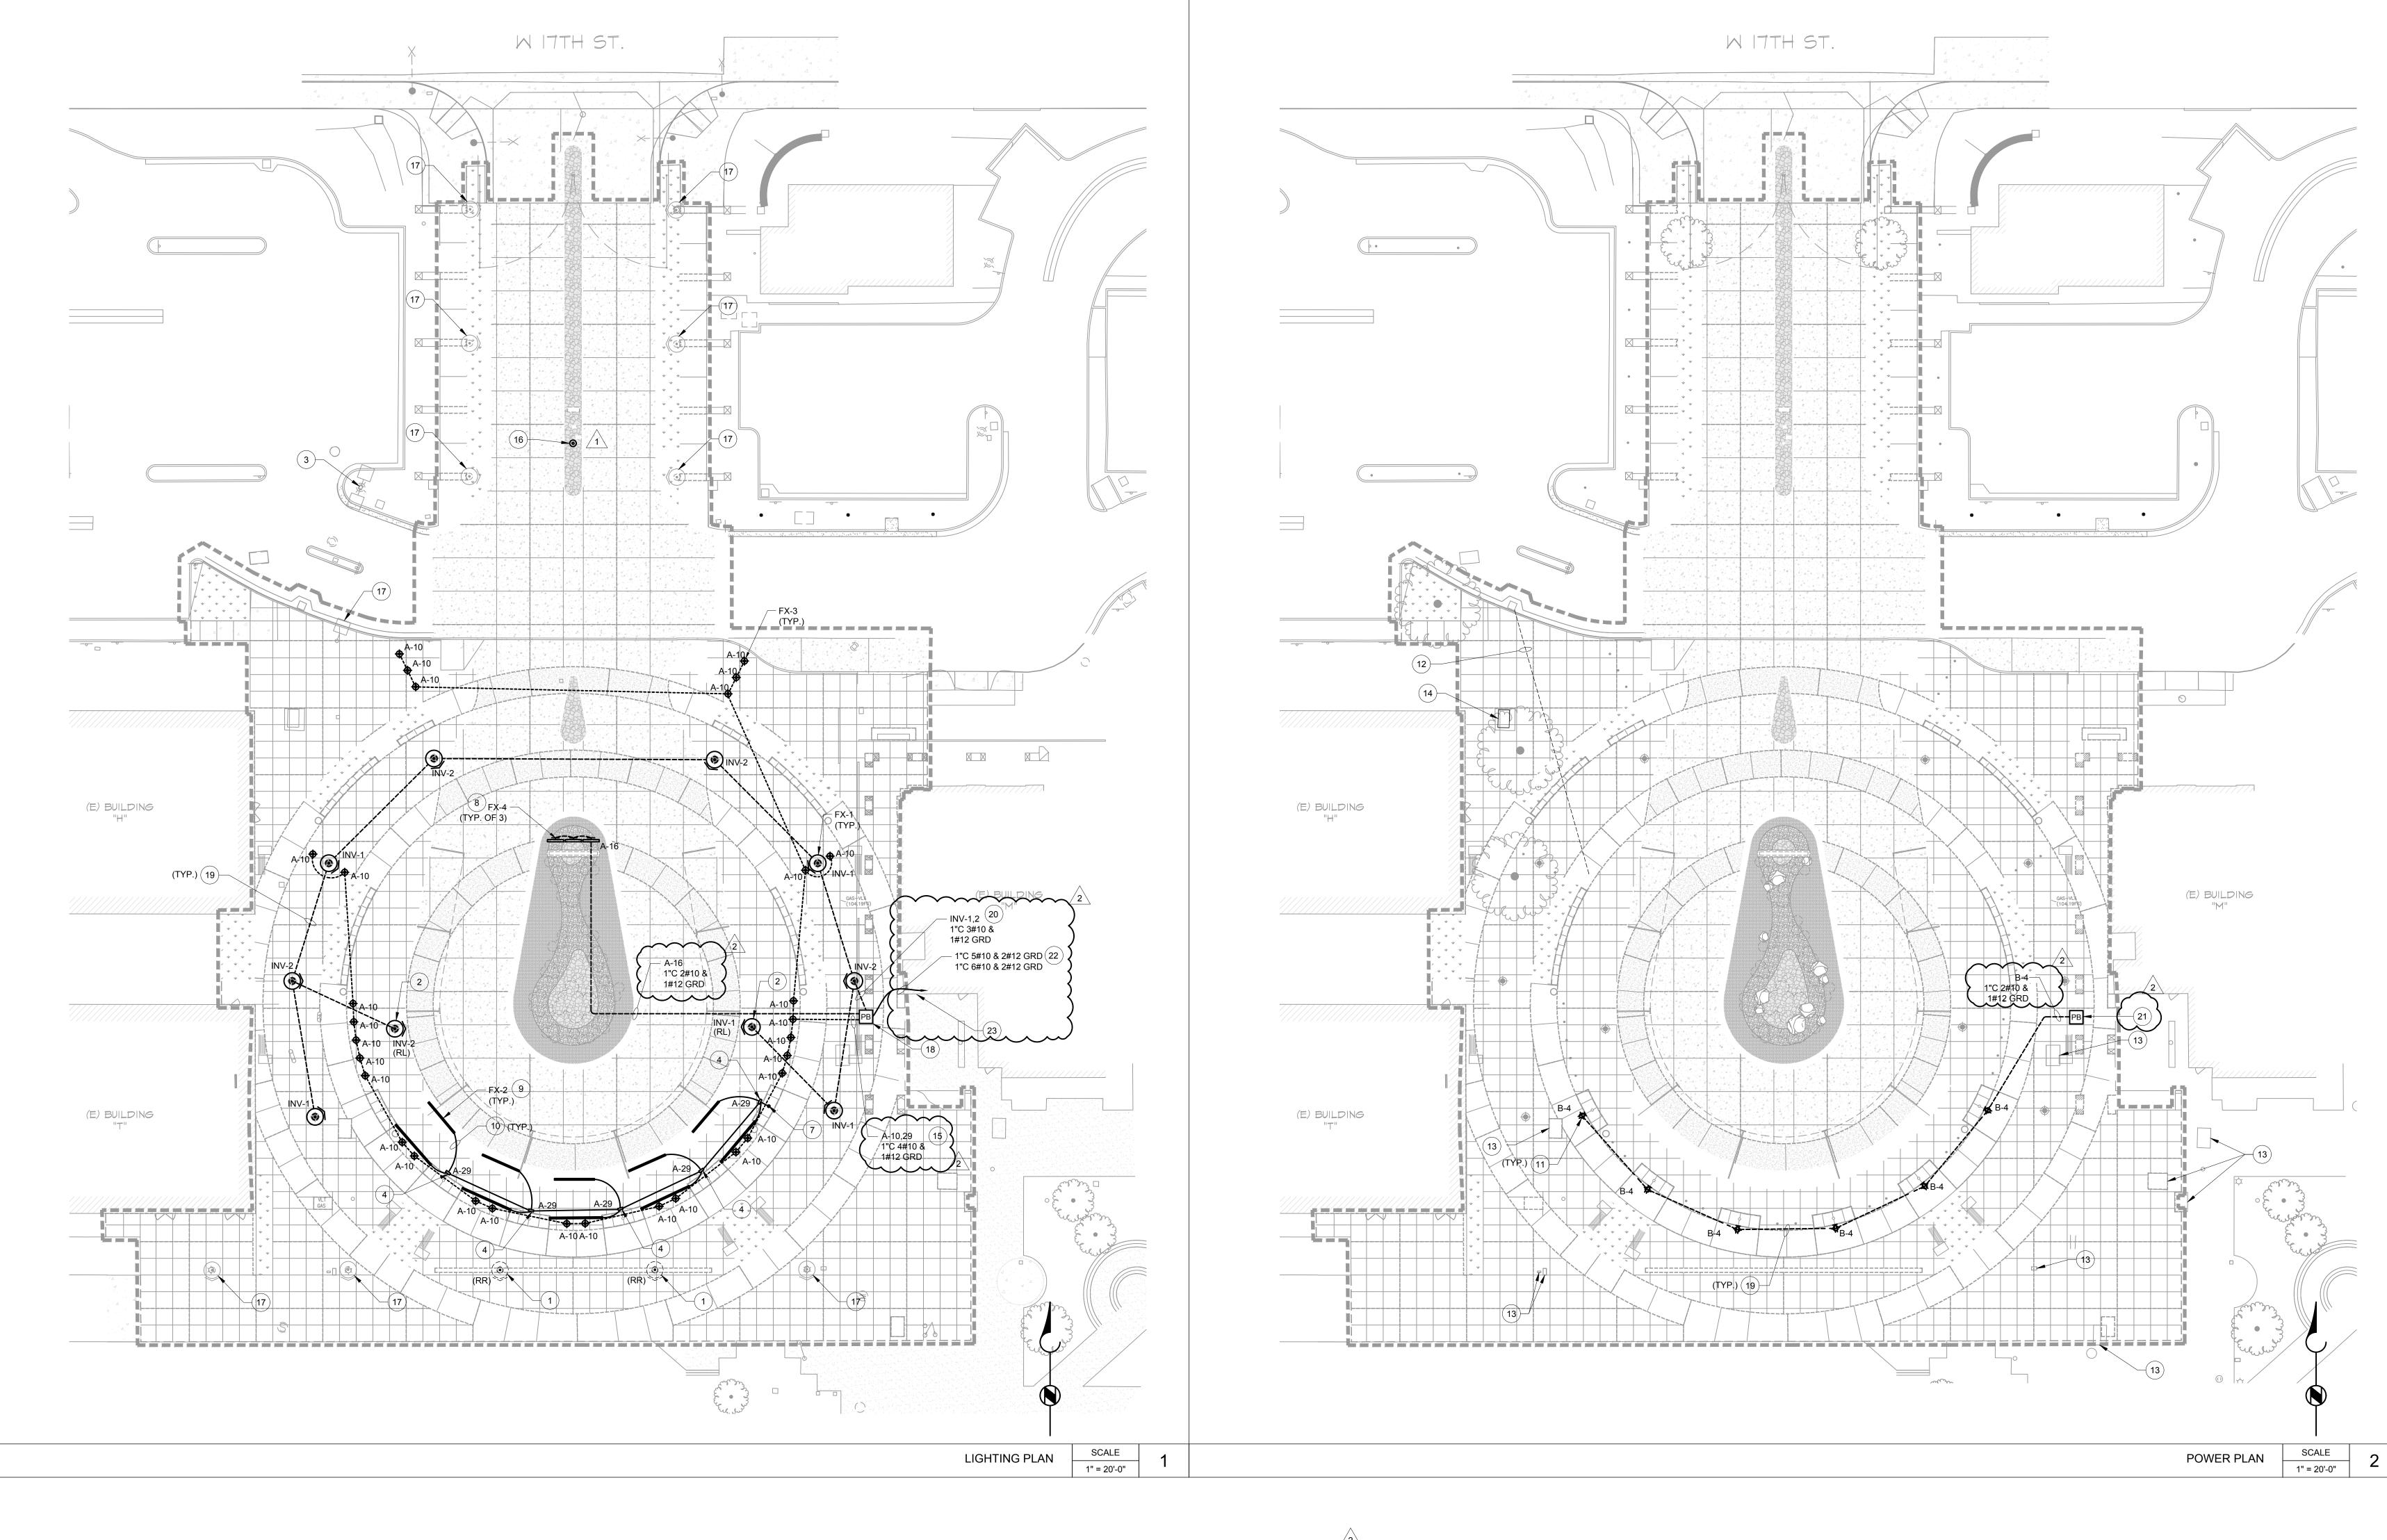

# GENERAL NOTES:

- 2. ANY ELECTRICAL AND/OR SIGNAL UTILITY SHUTDOWNS WITHIN THE AREA OF WORK SHALL BE COORDINATED AND SCHEDULED IN ADVANCE WITH THE COLLEGE'S REPRESENTATIVE TO NOT AFFECT CAMPUS SERVICES.
- 3. CONTACT DIG ALERT BEFORE DIGGING. ENSURE TO NOT DISTURB EXISTING POWER, FIRE ALRM, DATA AND FIBER OPTIC LINE.
- 4. ALL ELECTRICAL POWER, FIRE ALARM AND COMMUNICATION PULL BOXES AND VAULTS TO REMAIN AND BE PROTECTED IN PLACE, UNLESS OTHERWISE NOTED. ADJUST TO GRADE AS NEEDED.

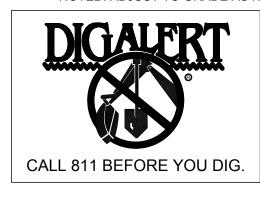

# RECONSTRUCTION NOTES:

- 1 EXISTING AREA LIGHT TO BE REMOVED AND RELOCATED LIGHT FOUNDATION TO BE REMOVED. DEMOLISH CONDUITS, WIRING AND SUPPORTS BACK TO NEAREST PULLBOX. MAINTAIN CIRCUIT CONTINUITY FOR EQUIPMENT/DEVICES TO REMAIN.
- NEW LOCATION OF RELOCATED LIGHT FIXTURE. CIRCUIT AS SHOWN. SEE DETAIL 1&2/E-5.1 FOR LIGHT FIXTURE DETAILS.
- 3 EXISTING FIXTURE TO REMAIN AND BE PROTECTED IN PLACE.
- REMOTE POWER SUPPLY FOR LINEAR LIGHTS INSTALLED UNDER CANOPY.
- PANEL 'A' & 'B' LOCATED IN BUILDING M, MAIN ELECTRICAL ROOM. ENLARGED ELECTRICAL ROOM ON 5/E-5.1 FOR REFERENCE.
- PROVIDE NEW INVERTER AND (2) TIME CLOCK. SEE ENLARGED ELECTRICAL ROOM ON 5/E-5.1 FOR MORE INFORMATION.
- 7 CONDUIT TO STUB UP INSIDE CANOPY COLUMN.
  COORDINATE CONDUIT (1 INCH) ROUTING WITH OTHERS TO
  AVOID STRUCTURAL BEAMS.

- 8 SIGN LIGHTS SPACED AT 5'-4" ON CENTER. 10' IN FRONT OF THE SIGN. ALIGN CENTER LIGHT WITH THE CENTER OF THE SIGN. SEE DETAIL 6/E-5.1 FOR MORE INFORMATION.
- ROUTE WIRING FROM POWER SUPPLY TO CANOPY LIGHTS INSIDE CANOPY BEAM. USE ACCESS HOLES CREATED BY CANOPY VENDOR

ALONG CANOPY SUPPORT BEAM.

WEATHER PROOF COVER.

9 FIXTURES TO BE MOUNTED BELOW CANOPY STRUCTURE

- CANOPY VENDOR.


  OUTLET ON SEAT WALL. PROVIDE GFCI RECEPTACLE WITH
- ABANDONED EMPTY COMMUNICATION CONDUIT TO BE REMOVED TO SOURCE.
- ELECTRICAL POWER/COMMUNICATION PULL BOX/VAULT TO REMAIN AND BE PROTECTED IN PLACE. ADJUST TO GRADE AS NEEDED.
- 14 EXISTING EMPTY ELECTRICAL VAULT TO BE REMOVED.


  15 PROVIDE A SEPARATE NEUTRAL FOR EACH CIRCUIT.


- CAMERA AND POLE TO BE REMOVED AND STORED DURING CONSTRUCTION OF CONCRETE WALKWAY/MERIDIAN FOR PROTECTION. FOOTING TO BE REMOVED, PROVIDE NEW FOOTING DURING REINSTALLATION. SEE DETAIL 1/E1.3 FOR CAMERA POLE BASE DETAIL.
- REMOVE AND REINSTALL EXISTING AREA LIGHT AND FOOTING TO BE FLUSH WITH NEW GRADE. SEE DETAIL 2/E-5.1 FOR FOOTING DETAIL.
- PROVIDE MIN 12'X6' PULL BOX LABELED 'ELECTRICAL'. SEE
- DETAIL 4/E-5.1 FOR MORE INFORMATION.

  (19) SEE 3/E5.1 FOR UNDERGROUND WIRING DETAIL.
- 20 ROUTE THROUGH TIME CLOCK A.

  (21) SEE PULL BOX ON LIGHTING PLAN.
- COMBINE ALL WIRING FOR PANEL 'A' INTO (1) 1" CONDUIT.
  COMBINE ALL WIRING FOR INVERTER AND PANEL 'B' (SEE POWER PLAN) INTO (1) 1" CONDUIT.

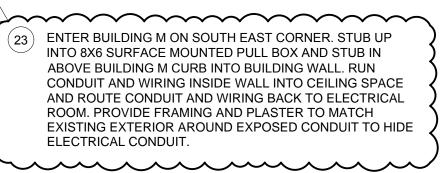

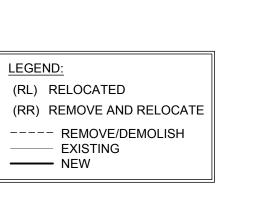

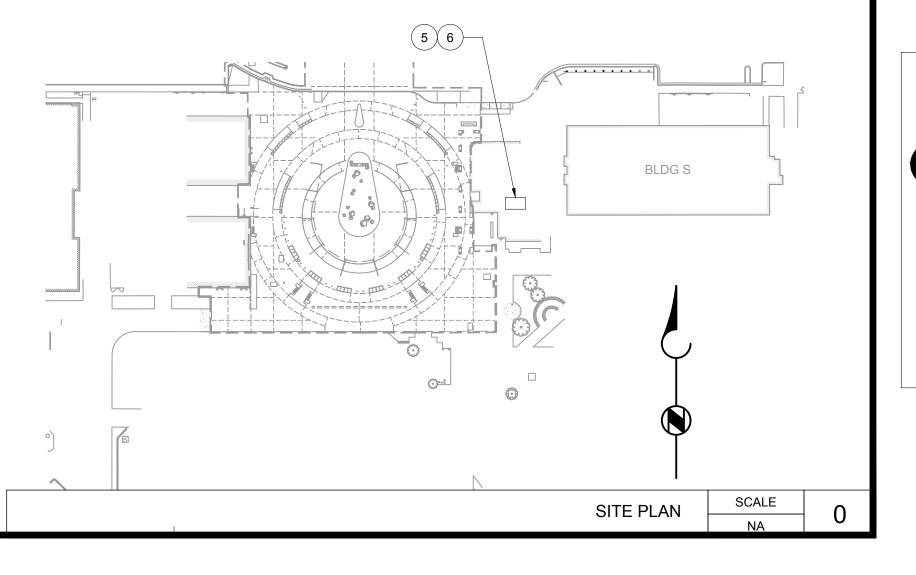

SANTA ANA COLLEGE CAMPUS ENTRY IMPROVEI PROJECT

No. E17083

No. E17083

DATE ISSUED: 2024-06-03

PROJECT NO: 2020-40160

DSA APPLICATION NO: 04-122485

SCALE:


SHEET
NUMBER:

E-1.2

POWER AND LIGHTING PLANS

SHEET TITLE:



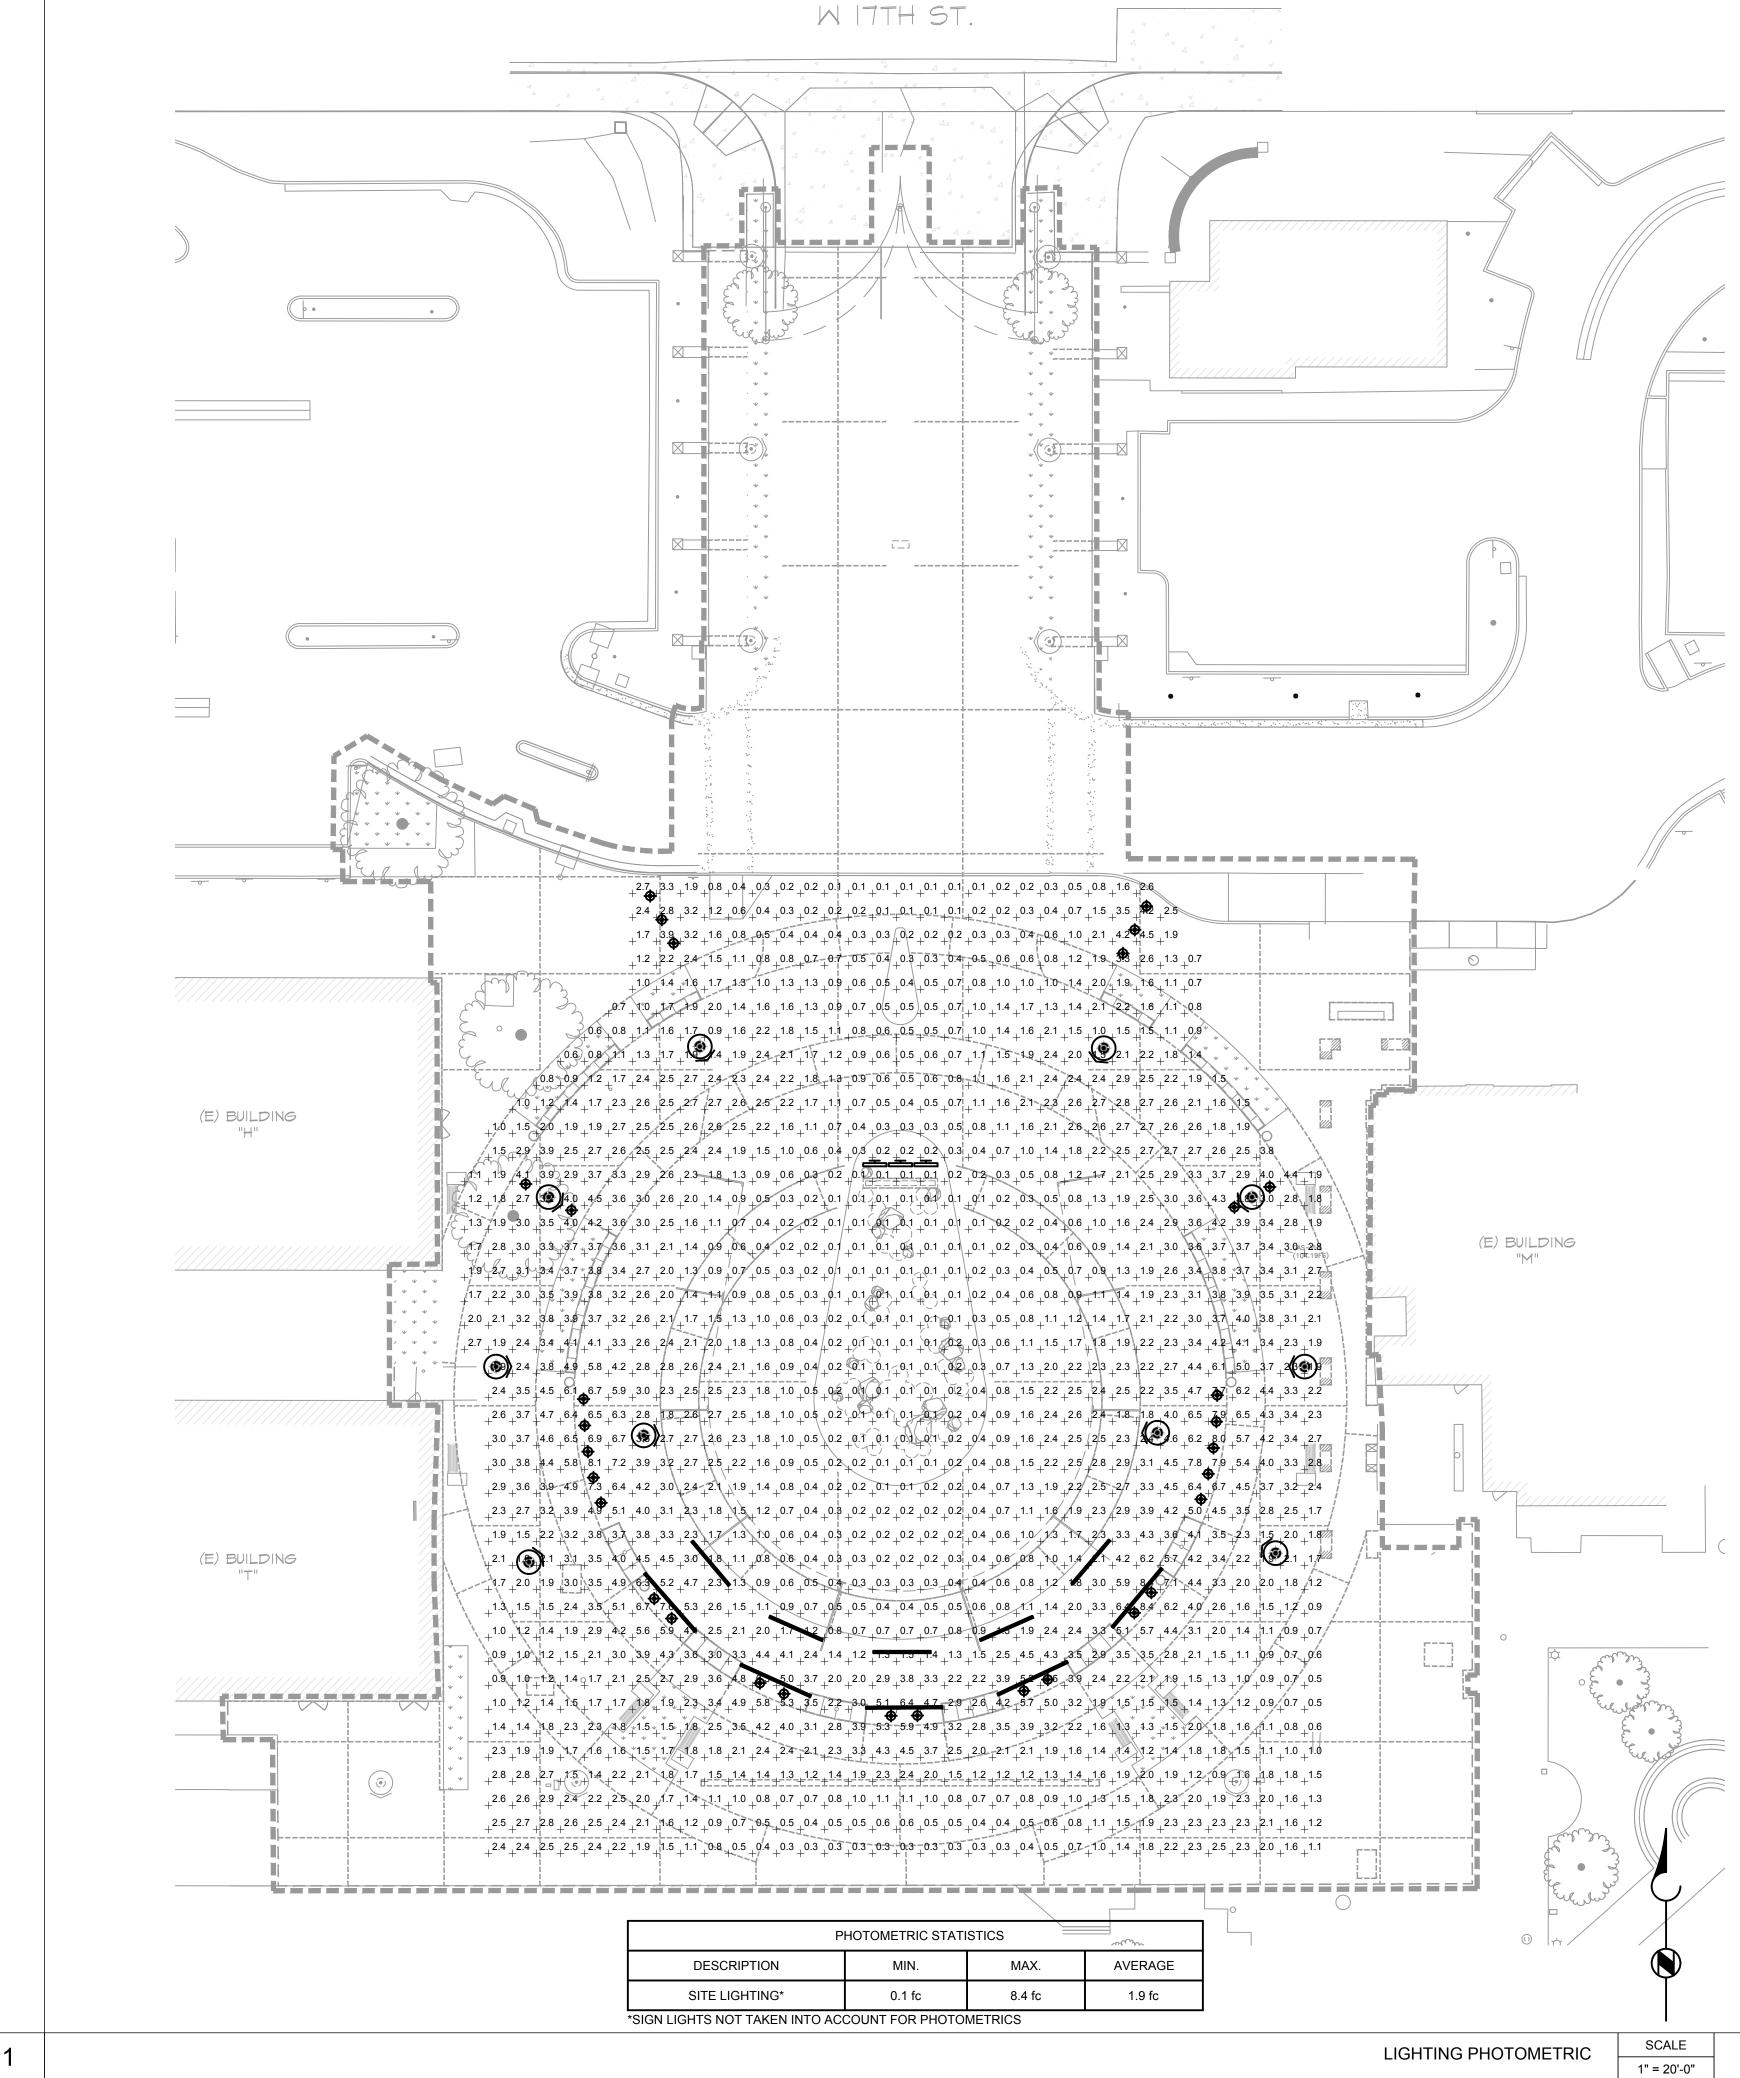

CAMERA POLE BASE DETAIL

N.T.S.

STRANDED #10 GROUND WIRE FROM LUG TO FIXTURE(S)

-PROVIDE (1) GROUND ROD PER CIRCUIT, #6

GROUND WIRE CLAMPED TO 5/8"x10' LONG

COPPER ROD W/CAST BRONZE CLAMP OR

- 6-#6 VERTICAL

SECTION A-A

WITH 2-1/2"

EXTEND CONDUIT WITH

**BUSHINGS UP 2" ABOVE** 

-3/4" CHAMFER

CADWELD, BY E.C.

SECTION A-A

3" CLR -

RELOCATE (E) CAMERA POLE (LESS THAN 34-FT TALL), (E) CAMERAS AND PROVIDE MOUNTING **GROUND & WIRING -**

4-3/4" DIAM GALVANIZED ANCHOR -BOLTS MIN, Fy= 36 KSI MIN

(ANCHORS BOLTS, BASE PLATE

AND LIGHT POLE PER MFR) PROVIDE BOLT COVER (TYP.)

BASE COVER -**LEVELING NUT &** 

**WASHERS SIZES** PER LIGHT POLE

MANUFACTURER

COVERS.

RECOMMENDATIONS

PROVIDE (1) GROUND ROD

LONG COPPER ROD W/CAST

PER CIRCUIT, #6 GROUND WIRE CLAMPED TO 5/8"x10'

BRONZE CLAMP OR

EXCAVATION, BACKFILL-

**CONCRETE BATCH PLANT AND SOIL INSPECTION NOTE:** 

BATCH PLANT INSPECTION FOR CONCRETE AND SOIL

INSPECTION PER DSA 103 AND CBC 1705A.3.3.2 IS

EXEMPT FOR THIS DETAIL

CADWELD, BY E.C.

& CONCRETE LIGHT POLE BASE BY G.C.

PROVIDE WITH BOLT


SCALE

# PHOTOMETRIC NOTES:

- 1. CALCULATION POINTS ARE 5' X 5' TYPICAL ON CENTER SPACING AT 0'-0" AFF.
- OTHER OBSTRUCTIONS ARE NOT INCLUDED IN THE CALCULATION RESULTS UNLESS DRAWN IN MODEL. 3. THE LIGHT FIXTURE USED FOR THE PHOTOMETRIC STUDY

2. TABLES, EQUIPMENT, PARTITIONS, STAIRS, SLOPE AND

- MAY VARY FROM THE LIGHT FIXTURE SCHEDULE ON SHEET E-5.1, DUE TO THE AVAILABILITY OF IES FILES. REFER TO SHEET E-5.1 FOR LIGHT FIXTURE SCHEDULE FOR THE COMPLETE SPECIFICATION AND MODEL NUMBER.
- 4. LUMINAIRE DATA IS OBTAINED ACCORDING TO IES PROCEDURES UNDER LABORATORY CONDITIONS. FIELD RESULTS MAY DIFFER FROM COMPUTER MODEL DUE TO MANY FACTORS INCLUDING BUT NOT LIMITED TO AMBIENT TEMPERATURE. LINE VOLTAGE VARIATION. INSTALLATION. REFLECTANCE AND OTHER SITE SPECIFIC CONDITIONS.
- 5. THIS LIGHTING PHOTOMETRIC STUDY IS NOT A SUBSTITUTE FOR AN INDEPENDENT ENGINEERING ANALYSIS AND THE COORDINATION OF LIGHTING SYSTEM SUITABILITY, FIXTURE PLACEMENT, FIXTURE SELECTION AND SAFETY TO COMPLY WITH LOCAL BUILDING CODES AND PROJECT PROGRAMMING.

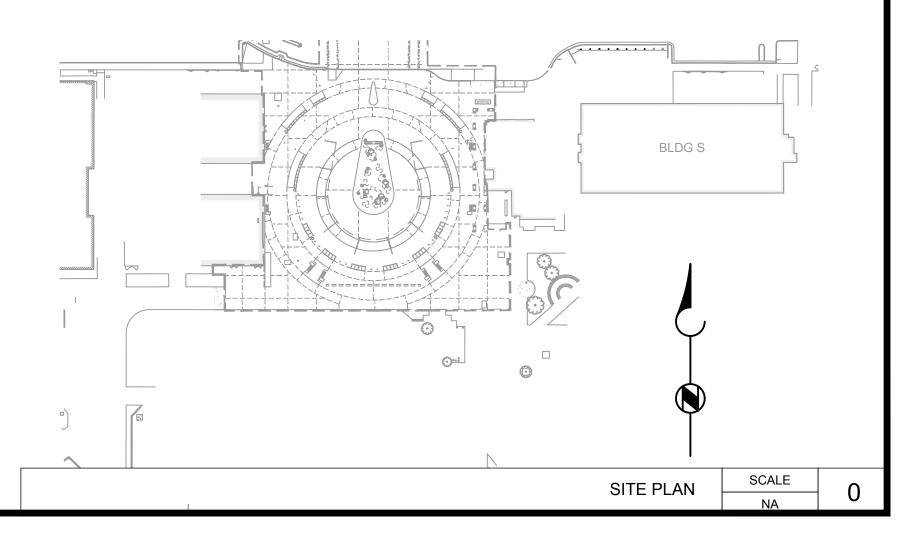

# SAN PRO

9

C

**REVISIONS:** DATE DESCRIPTION 05/14/2024 ADDENDUM 1

2024-02-09 **DATE ISSUED:** PROJECT NO: 2020-40160 **DSA APPLICATION NO:** 04-122485 SCALE: E-1.3 SHEET **NUMBER:** 

**PHOTOMETRIC PLANS** 

SHEET TITLE:



# - CONCRETE STEEL SLURRY REINFORCED (TYPICAL) **BOLT DOWN LID** LED LIGHT PULLBOX PLACEMENT DIAGRAM FIXTURE SHOWN HERE IS FOR DESIGN INTENT ONLY. CONTRACTOR TO FIELD COORDINATE. (MATCH EXISTING) LIGHT FIXTURE WEIGHT: 42 LBS. MAX EPA @100MPH WINDS: 1.13 WEIGHT: 35LBS. FINISH GRADE MAX EPA @100MPH WINDS: 2.1 -NEW CONCRETE LIGHT POLE BASE (SEE DETAIL 2/E-5.1) REINFORCED CONCRETE PULLBOX (EXTEND AS REQUIRED) CONCRETE PAVEMENT -ELECTRICAL INCOMING CONDUIT CONDUITS (IN/OUT) —OUTGOING CONDUIT

PANEL:		Α		EXISTIN	NG (SIEM	IENS)												
LOCATION :	BUILDING M	, ELECTRICA	AL ROOM				VO	LTAGE/ F	HASE :	240/120\	/, 1Ø, 3W	/				FED	FROM:	
MOUNTING :	SURFACE							BUS	AMPS :	100A						R	ATING :	10,000A
NEMA :	1						M	IAIN BRE	AKER:									
	SEE *		OUTLETS		VOLT-	amps T		BKR/		BKR/		T voi-	T-AMPS	OUTLET	···	*	SEE	
LOADS	NOTE	LTG	REC	MISC	A	В	aкт	POLE	ABC	POLE	акт	A	B LT		MISC	1	NOTE	LOADS
LOP POWER					540		1	20/1	*_	20/1	2	540						M116 REC
M116 REC						540	3	20/1	_*_	20/1	4		540					M116 REC
M116 REC					540		5	20/1	_*	20/1	6	540						M116 REC
M116 REC						540	7	20/1	*	20/1	8		900					HAND DRYER - MENS
RESTROOM LIGHT					1,438		9	20/1	_*_	20/1	10	500					1,2	MAIN ENTRANCE BOLLARD
EXT UP / DOWN LTS						1,105	11	20/1	_*	20/1	12		900					HAND DRYER - WOMENS
EXT WINDOW LTS					1,252		13	20/1	*	20/1	14	500						PLAYER LTG CONTROL
RESTROOM PLUMB SENSORS						600	15	20/1	_*_	20/1	16		120				1,2	MAIN ENTRANCE SIGN
INTERIOR LIGHTS					895		17	20/1	_*	20/1	18	180						ROOF REC
INTERIOR LIGHTS						513	19	20/1	*	20/1	20		160					SMOKE FIRE DAMPER
M104, M120 REC					540		21	20/1	_*_	20/1	22	200						FACP POWER
M109, M120 REC						540	23	20/1	_*	20/1	24		200					ELEC DOOR POWER
M105, M120 REC					540		25	20/1	*	20/1	26	540						M120 REC
M120, M122 REC						540	27	20/1	_*_	20/1	28		540					M120, M124 REC
MAIN ENTR CANOPY LTS	1,2				342		29	20/1	_*	20/1	30	540						M104, M109, M120 REC

72 AMPS

TOTAL VA VOLTAGE

(120/277)

24

(120/277)

(120/277)

57

4.5 VA/FT

17

LAMPS

LED 3000K

LED 3000K

LED 3000K

LED 3000K

MOUNTING

POLE

**BOLLARD** 

STANCHION

REMARKS

MOUNT AT 16' PROVIDE 4" STEEL ROUND POLE WITH 12" DIAMETER BASE

COVER AND MATCH COLOR TO EXISTING AREA LIGHTS

PROVIDE WITH SCP ACCESSORY FOR OCCPANCY DETECTION

SEE A-31.3 FOR TOTAL RUN LENGTH

MOUNT AT 10' IN FRONT OF SIGN, AT SPACING OF 5'-4" ON

LIGHT FIXTURE SCHEDULE

SURFACE PROVIDE WITH OUTDOOR 2X96W 0-10V DIMMING POWER

LIGHTING FIXTURE SCHEDULE

AREA LIGHTS

2920 LUMEN, 3000K

TIVOLI: TRCE-H-H-30-24

144 LUMEN/FT, 3000K BOLLARD LIGHTING

♦ FORMS AND SURFACES: LBLCO-604

1545 LUMEN/FT, 3000K

4500 LUMEN, 3000K

SIGN LIGHT

POWER SUPPLY: ADNM-240-2-4-24-DOT

KIM LIGHTING: INT-3-36L-40-3K7-HF-UNV-A12-SM18

LCL = 0 VOLT-AMPS

TOTAL PANEL = 17,365 VA @ 240V, 1Ø =

LINEAR FIXTURE

DESCRIPTION

ARCHITECTURAL LIGHTING: SP1-STR-Y3-32LED-3K-550-COP-SCP

CALL OUT SYMBOL

FX-2

FX-3

┌─ (E) PANEL 'B' 1 (N) INVERTER - (N) TIME CLOCK B ( 3 )−(N) TIME CLOCK A (2)

UNDERGROUND PULL BOX DETAIL


# **RECONSTRUCTION NOTES:**

LABEL TIME CLOCK 'CANOPY REC'.


N.T.S.


- 1 PROVIDE (N) 120V, 1P, 750W, 80LBS INVERTER WITH (3) 20A BREAKERS, MYERS LV-4-R-1-B2003.
- 2 ASTRONOMICAL 365 DAY TIME CLOCK A TO TURN ON ALL ENTRANCE LIGHTS DURING NIGHT TIME HOURS. LABEL TIME CLOCK 'MAIN ENTRANCE LTS'.
- 3 PROGRAM 7-DAY TIME CLOCK B TO TURN ON POWER FOR RECEPTACLES DURING OPERATION HOUR (6AM TO 10PM).

DANEL IAI	SCALE	0		SCALE	
PANEL 'A'	N.T.S.	0	ENLARGED ELECTRICAL ROOM	1/4" = 1'-0"	

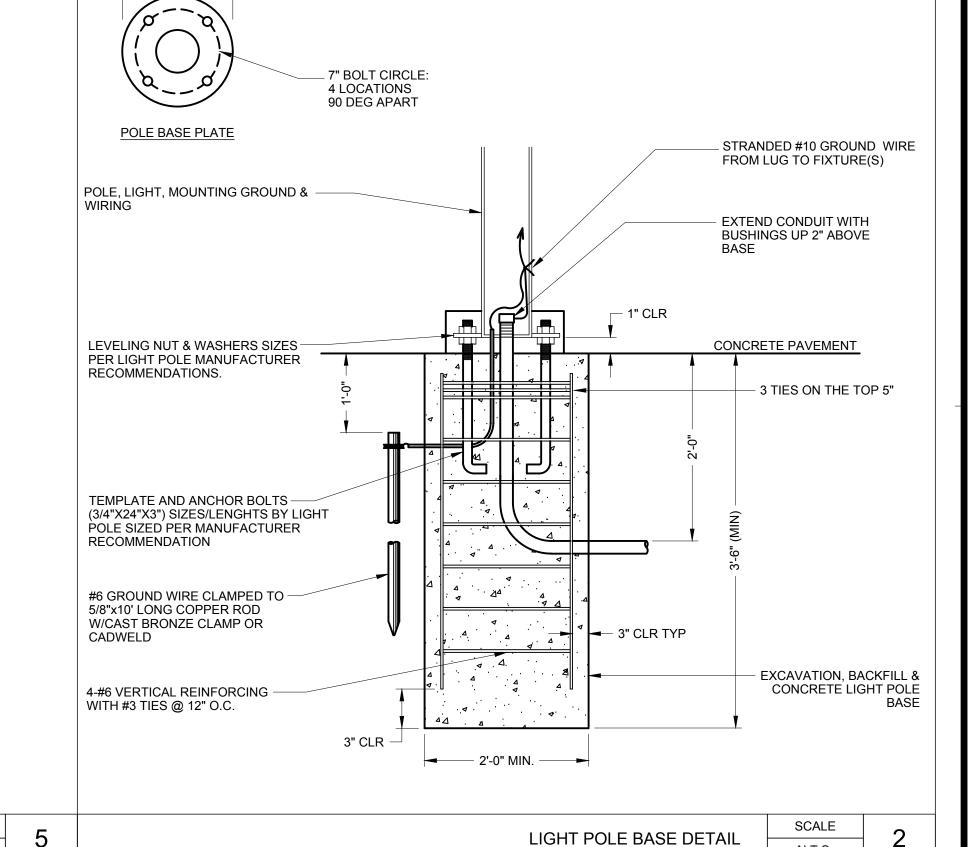


LIGHT POLE DETAIL

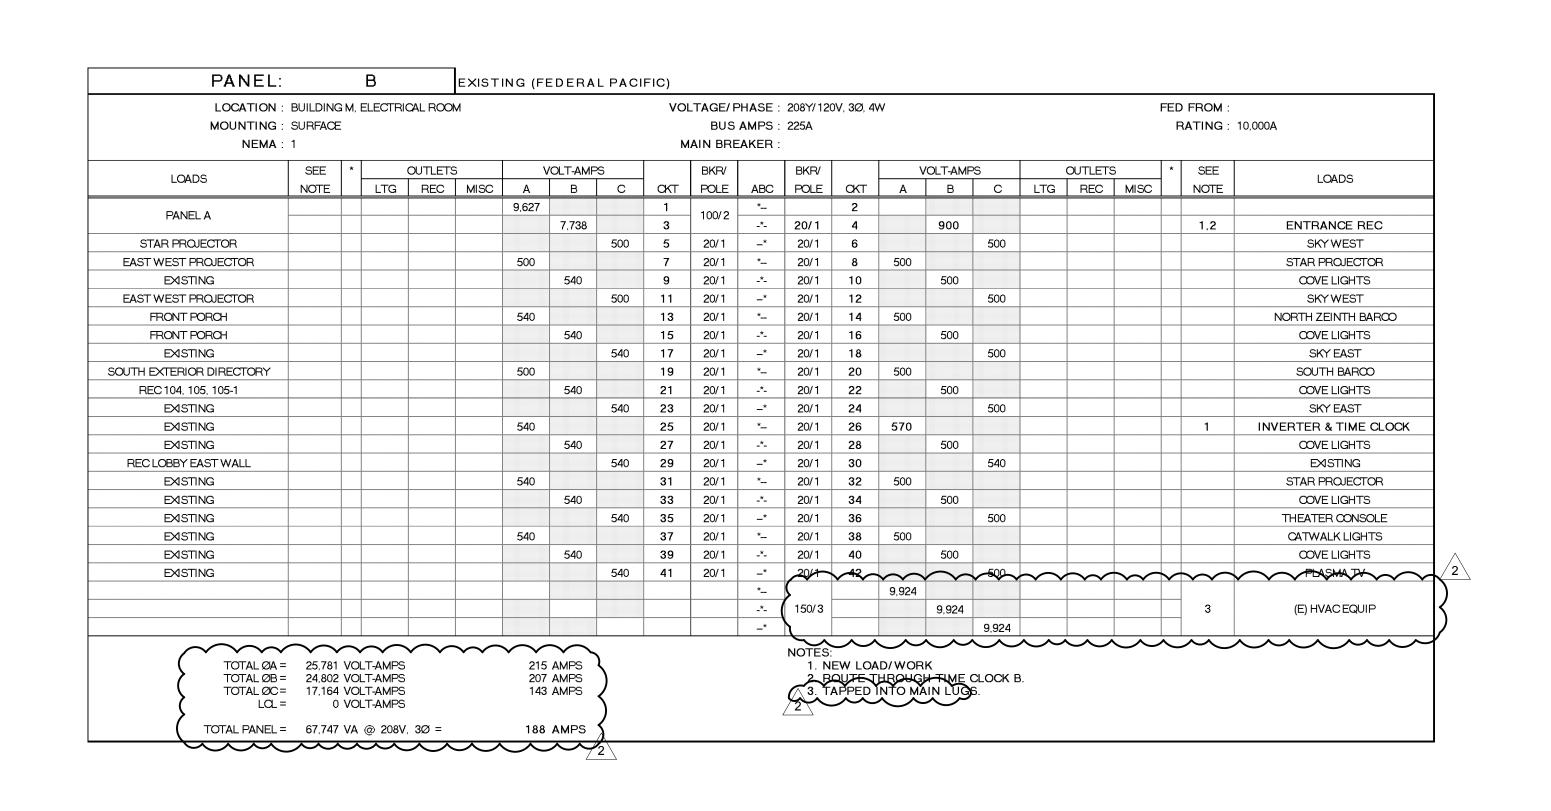

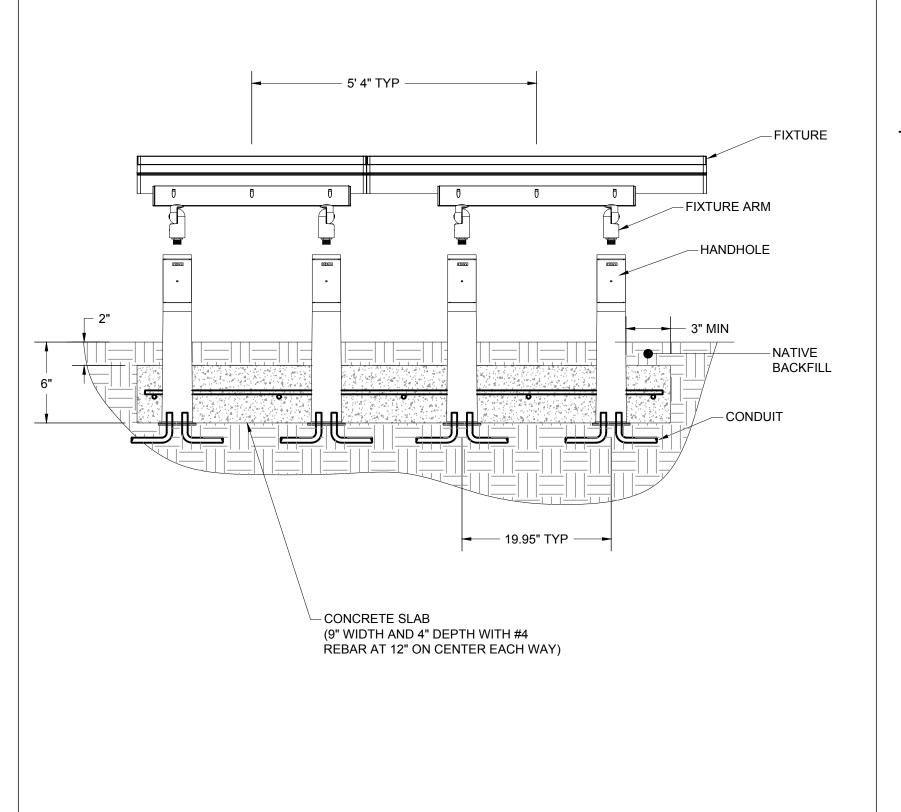

SIGN LIGHTING MOUNTING DETAIL

N.T.S.

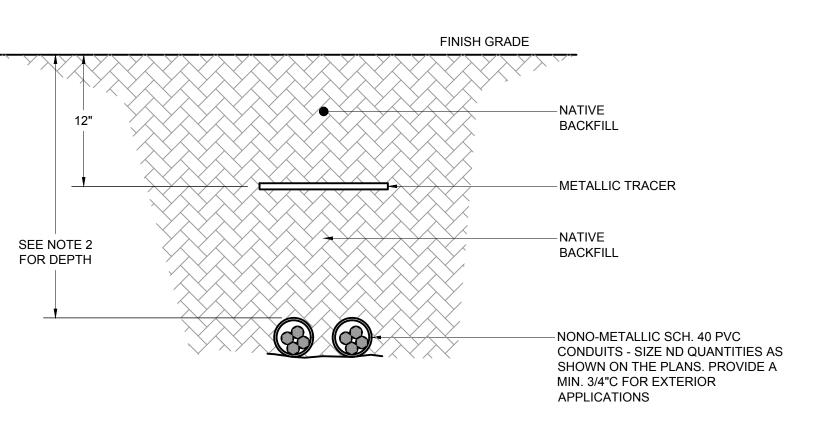

# NOTE/S:

- 1. PLACE CONDUIT IN TRENCH, FILL, AND COMPACT TO 90% REPAIR AREA TO MATCH SURROUNDINGS. BACK FILL IS TO BE FREE FROM LARGE ROCKS, PAVING MATERIALS, ETC. THAT MAY CAUSE PHYSICAL DAMAGE TO CONDUIT.
- 2. PROVIDE 24" MINIMUM COVER WHERE CONDUIT IS PLACED UNDER STREETS, ROADS AND PARKING LOTS. PROVIDE 18"
- 3. BACKFILL TRENCH WITH ASPHALT TO MATCH EXISTING CONDITIONS.

MINIMUM COVER WHERE CONDUIT FOR ALL OTHER SITUATIONS.

CONDUIT BURIAL DETAIL

N.T.S.

TRIC

DIS

0

OMMUNIT

DATE

**REVISIONS:** 

N.T.S.

DATE ISSUED:	2024-06-
<u> </u>	202100
PROJECT NO:	2020-401
DSA APPLICATION NO:	04-1224

**DESCRIPTION** 

ADDENDUM 2

E-5.1 SHEET **NUMBER:** SHEET TITLE: **ELECTRICAL** 

**DETAILS AND** 

SCHEDULES

255 East Rincon St., Suite 301 Corona, CA 92879 P 951.340.1977 | F 951.340.1090 FILE NO.: 120-10-02

- 13. Concrete pumping locations.
- 14. Crane locations.
- 15. Location of portable sanitary facilities.
- 16. Mixer truck wash out locations.
- 17. Traffic control signage.
- 18. Perimeter and site lighting.
- 19. Stockpile and/or lay down areas.
- 20. Emergency Vehicle Access Routes.
- B. A revised Project site logistic plan may be required by the District Representative for separately identified phases of the Work as set forth in this Section.
- C. Contractor is responsible for securing and obtaining all approvals and permits from authorities having jurisdiction relative to logistic plan activities.

# 3.03 PHASING OF THE WORK

- A. Project will be constructed in separate Milestone increments, as identified or as described in this Section and/or the Contract Documents. Phasing will also delineate Work to be completed in each designated phase. Unless otherwise approved or directed by the District Representative, each phase shall be completed according to the approved Construction Schedule prior to the commencement of the next subsequent phase. Contractor shall incorporate and coordinate the Work of Separate Work Contracts relative to this Project into the Phasing and Construction Schedule.
- B. Contractor shall install all necessary Work for phased Work before completion of the designated phase.

# PHASING OF THE WORK – GENERAL

- A. Contractor shall prepare the Milestone Schedule in order to complete the Work and related activities in accordance with the phasing plan. Contractor shall include all costs to complete all Work within the Milestones and Contract Time.
- B. Owner will be seriously damaged by not having all Work completed within the Milestones and/or Contract Time. It is mandatory the Work be complete within the Milestones and Contract Time.

# 3.05 PHASING OF THE WORK – SPECIFIC

- A. Contractor shall prepare Construction Schedule, and shall complete the following Milestones, but not limited to, within the designated phases in accordance with the following:
  - 1. Phase 1 Submittals/Mobilization (35x10 days) calendar days from NTP. ADD-3
  - 2. Phase 2 Substantial Completion (365 days) dalendar days from NT
  - 3. Phase 3 Punch List Correction 40 days ) calendar days from NTP Substantial Completion

410 days

4. Phase 4 Final Completion Date – (390 days) calendar days from NTP

END OF SECTION 01 12 16

Phase 1 - The walk Area (West Side of Building "M") shall be treated as a separate phase to allow occupancy to Bldg M

Phase 2 - Walk Area Adjacent to Building "H" and "T". Work to be phased to times when Campus is closed (Winter Break 2024 or Summer 2025) to be coordinated with the District

3.04

Phase 3 -General Area

Santa Ana College Campus Entrance Improvements – 100% CD Rancho Santiago Community College District July 21, 2023

- 3. Contractor shall remove the storage unit from the Project site when the storage unit is no longer required for the Work or upon Substantial Completion of the Work.
- 4. Contractor shall at their expense and without limitation remove and/ or relocate storage units as rapidly as required in order to provide for progress of the Work.

# J. Temporary Sanitary Facilities:

- 1. Contractor shall provide portable chemical toilet facilities, hand wash facilities, and trash receptacles. Quantity of units shall be based on total number of workers and shall be in accordance with Cal/OSHA standards and in compliance with SWPPP.
- 2. Portable chemical toilet facilities, hand wash facilities, and trash receptacles shall be maintained with adequate supplies and in a clean and sanitary condition and shall be removed from the Project site upon Substantial Completion of the Work. Contractor shall maintain District Representative trailer restroom clean and operational at all times.
- 3. Contractor employees shall not use school toilet facilities.
- 4. At Contractor's expense and without limitation remove and/or relocate portable chemical toilet facilities as rapidly as required in order to provide for progress of the Work.
- 5. Contractor will contain their breaks and lunch periods to the areas designated by District Representative or any public area outside the Project site. Contractor shall provide a suitable container within the break/lunch area for the placement of trash. Areas used for break/lunch must be maintained clean and orderly. Once finish flooring has been installed in a particular area, no food or beverages will be permitted in that area.

# K. Temporary Security Fence/Barricade:

1. Contractor shall install temporary Project site security barricade(s) as indicated on Drawings or as required for safety and as specified herein. New or used material may be furnished. Security of Project site and contents is a continuous obligation of Contractor.


ADD-3

2. Unless otherwise indicated or specified, security fence shall be constructed of 6-foot high chain link fencing with 6-foot high green screen. Post spacing shall not exceed ten feet on center. Posts shall be of following nominal pipe dimensions: terminal, corner, and gatepost 2 ½-inches, line posts 2-inch. Chain link fence shall be not less than #13 gauge, 2-inch mesh, and in one width. Posts, fence and accessories shall be as follows:

ADD-3

8-foot high

- a. Shall be on T-stands with sand bags, unless required otherwise in writing by District Representative.
- a. Green screen shall be attached to fence mesh on the construction side of the fence and steel tension wires at 18-inch centers with a minimum of #14 gauge tie wire. Green screen shall be maintained and all rips, tears, missing sections shall be corrected upon notification by District Representative.
- b. Gates shall be fabricated of steel pipe with welded corners, and bracing as required. Fence and fabric to be attached to frame at 12-inch on center. Provide all gate hardware of a strength and quality to perform satisfactorily until barricade is removed upon Substantial Completion of the Work. Each gate shall have a chain and combo padlock. At Substantial Completion of the Work, remove barricade from Project site, backfill and compact fence footing holes. Existing surface paving that is cut into or removed shall be patched and sealed to match surrounding areas.
- c. At Contractor's expense and without limitation remove or relocate fencing, fabric and barricades or other security and protection facilities as rapidly as required in order to provide for progress of the Work.
- L. Other Temporary Enclosures and Barricades:

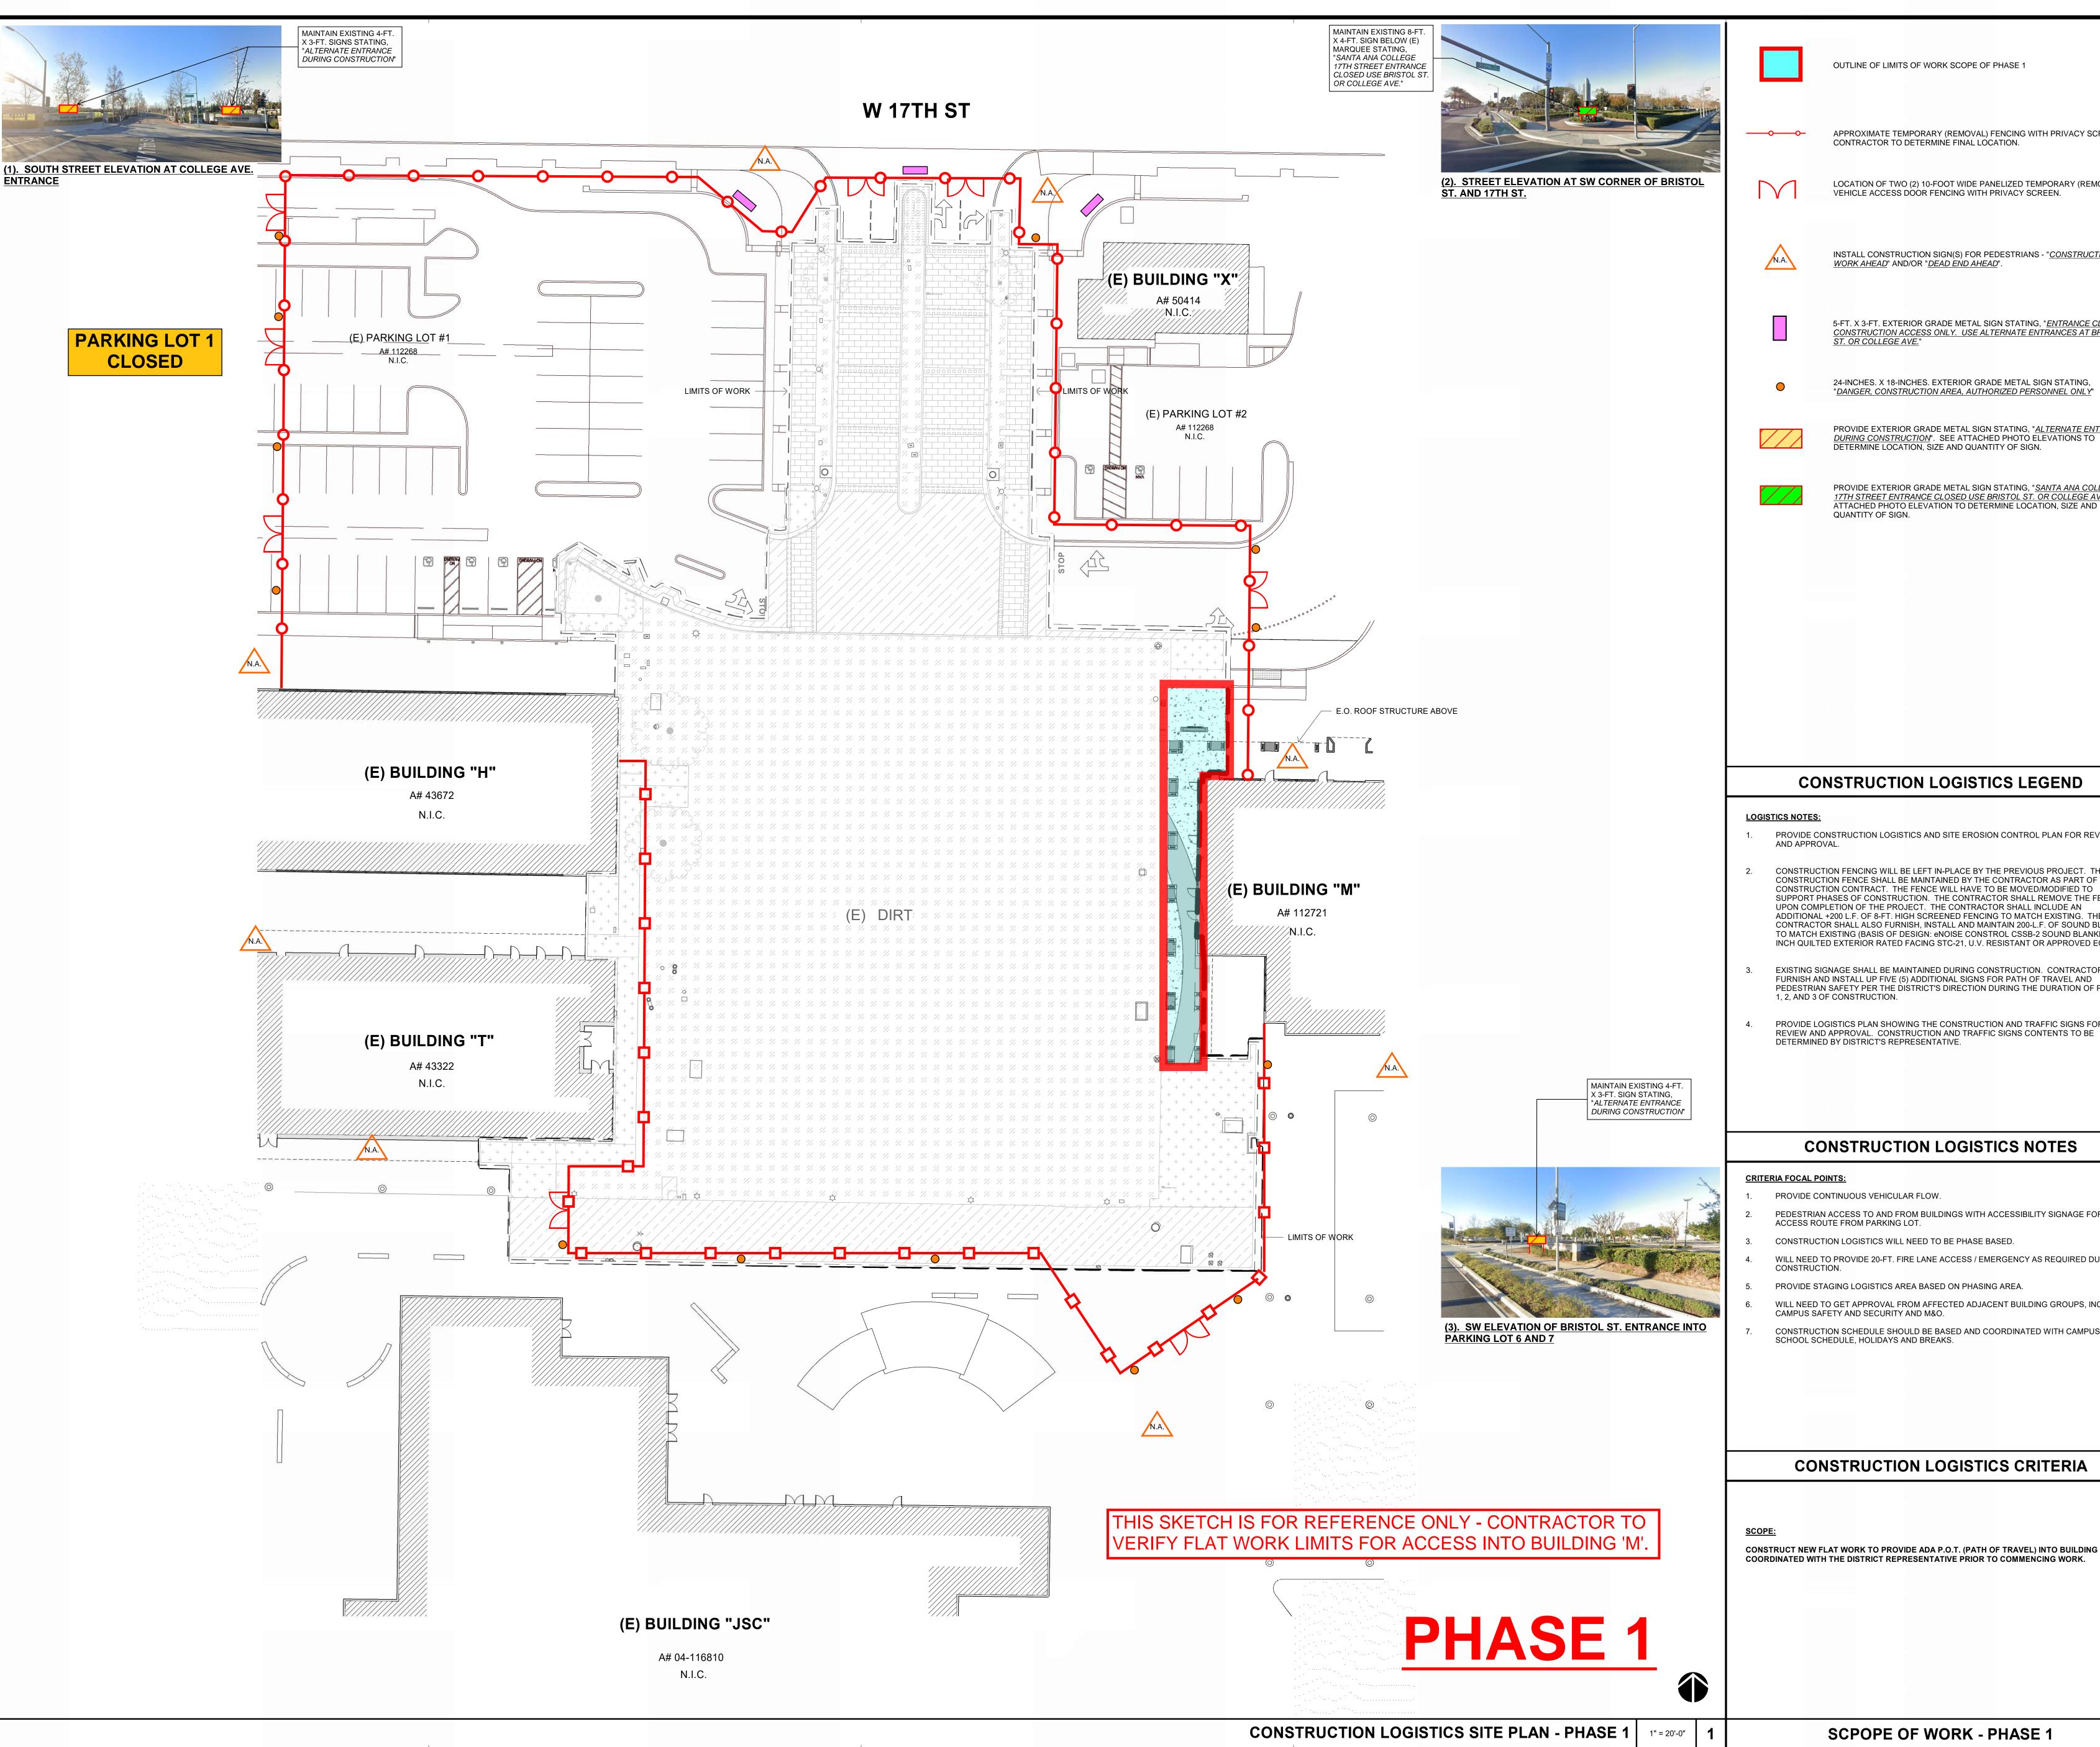

OUTLINE OF LIMITS OF WORK SCOPE OF PHASE 1

APPROXIMATE TEMPORARY (REMOVAL) FENCING WITH PRIVACY SCREEN. CONTRACTOR TO DETERMINE FINAL LOCATION.

LOCATION OF TWO (2) 10-FOOT WIDE PANELIZED TEMPORARY (REMOVAL) VEHICLE ACCESS DOOR FENCING WITH PRIVACY SCREEN.

INSTALL CONSTRUCTION SIGN(S) FOR PEDESTRIANS - "CONSTRUCTION WORK AHEAD" AND/OR "DEAD END AHEAD".

> 5-FT. X 3-FT. EXTERIOR GRADE METAL SIGN STATING, "ENTRANCE CLOSED, CONSTRUCTION ACCESS ONLY. USE ALTERNATE ENTRANCES AT BRISTOL ST. OR COLLEGE AVE."

DIS

**REVISIONS:** 

**DATE ISSUED:** 

PROJECT NO:

SHEET TITLE:

PHASE 1

SCALE:

SHEET NUMBER:

**DSA APPLICATION NO:** 04-122485

CONSTRUCTION

LOGISTICS PLN -

DESCRIPTION

DATE

2021-07-19

2020-40160

As indicated

GEN-5

24-INCHES. X 18-INCHES. EXTERIOR GRADE METAL SIGN STATING, "DANGER, CONSTRUCTION AREA, AUTHORIZED PERSONNEL ONLY"

PROVIDE EXTERIOR GRADE METAL SIGN STATING, "ALTERNATE ENTRANCE <u>DURING CONSTRUCTION</u>". SEE ATTACHED PHOTO ELEVATIONS TO DETERMINE LOCATION, SIZE AND QUANTITY OF SIGN.

PROVIDE EXTERIOR GRADE METAL SIGN STATING, "SANTA ANA COLLEGE 17TH STREET ENTRANCE CLOSED USE BRISTOL ST. OR COLLEGE AVE.". SEE ATTACHED PHOTO ELEVATION TO DETERMINE LOCATION, SIZE AND QUANTITY OF SIGN.

# CONSTRUCTION LOGISTICS LEGEND

PROVIDE CONSTRUCTION LOGISTICS AND SITE EROSION CONTROL PLAN FOR REVIEW

- FURNISH AND INSTALL UP FIVE (5) ADDITIONAL SIGNS FOR PATH OF TRAVEL AND PEDESTRIAN SAFETY PER THE DISTRICT'S DIRECTION DURING THE DURATION OF PHASES
- PROVIDE LOGISTICS PLAN SHOWING THE CONSTRUCTION AND TRAFFIC SIGNS FOR

# **CONSTRUCTION LOGISTICS NOTES**

PROVIDE CONTINUOUS VEHICULAR FLOW.

- PEDESTRIAN ACCESS TO AND FROM BUILDINGS WITH ACCESSIBILITY SIGNAGE FOR
- CONSTRUCTION LOGISTICS WILL NEED TO BE PHASE BASED.
- PROVIDE STAGING LOGISTICS AREA BASED ON PHASING AREA.
- WILL NEED TO GET APPROVAL FROM AFFECTED ADJACENT BUILDING GROUPS, INCLUDING CAMPUS SAFETY AND SECURITY AND M&O.
- CONSTRUCTION SCHEDULE SHOULD BE BASED AND COORDINATED WITH CAMPUS SCHOOL SCHEDULE, HOLIDAYS AND BREAKS.

# CONSTRUCTION LOGISTICS CRITERIA


CONSTRUCT NEW FLAT WORK TO PROVIDE ADA P.O.T. (PATH OF TRAVEL) INTO BUILDING "M". COORDINATED WITH THE DISTRICT REPRESENTATIVE PRIOR TO COMMENCING WORK.



NOT BE USED FOR ANY OTHER PURPOSE AND MAY NOT BE REPRODUCED OR

DISCLOSED TO OTHERS WITHOUT THE PRIOR WRITTEN CONSENT OF SVA ARCHITECTS INC. ALL RIGHTS RESERVED, © COPYRIGHT 2020.

**SCPOPE OF WORK - PHASE 1** 

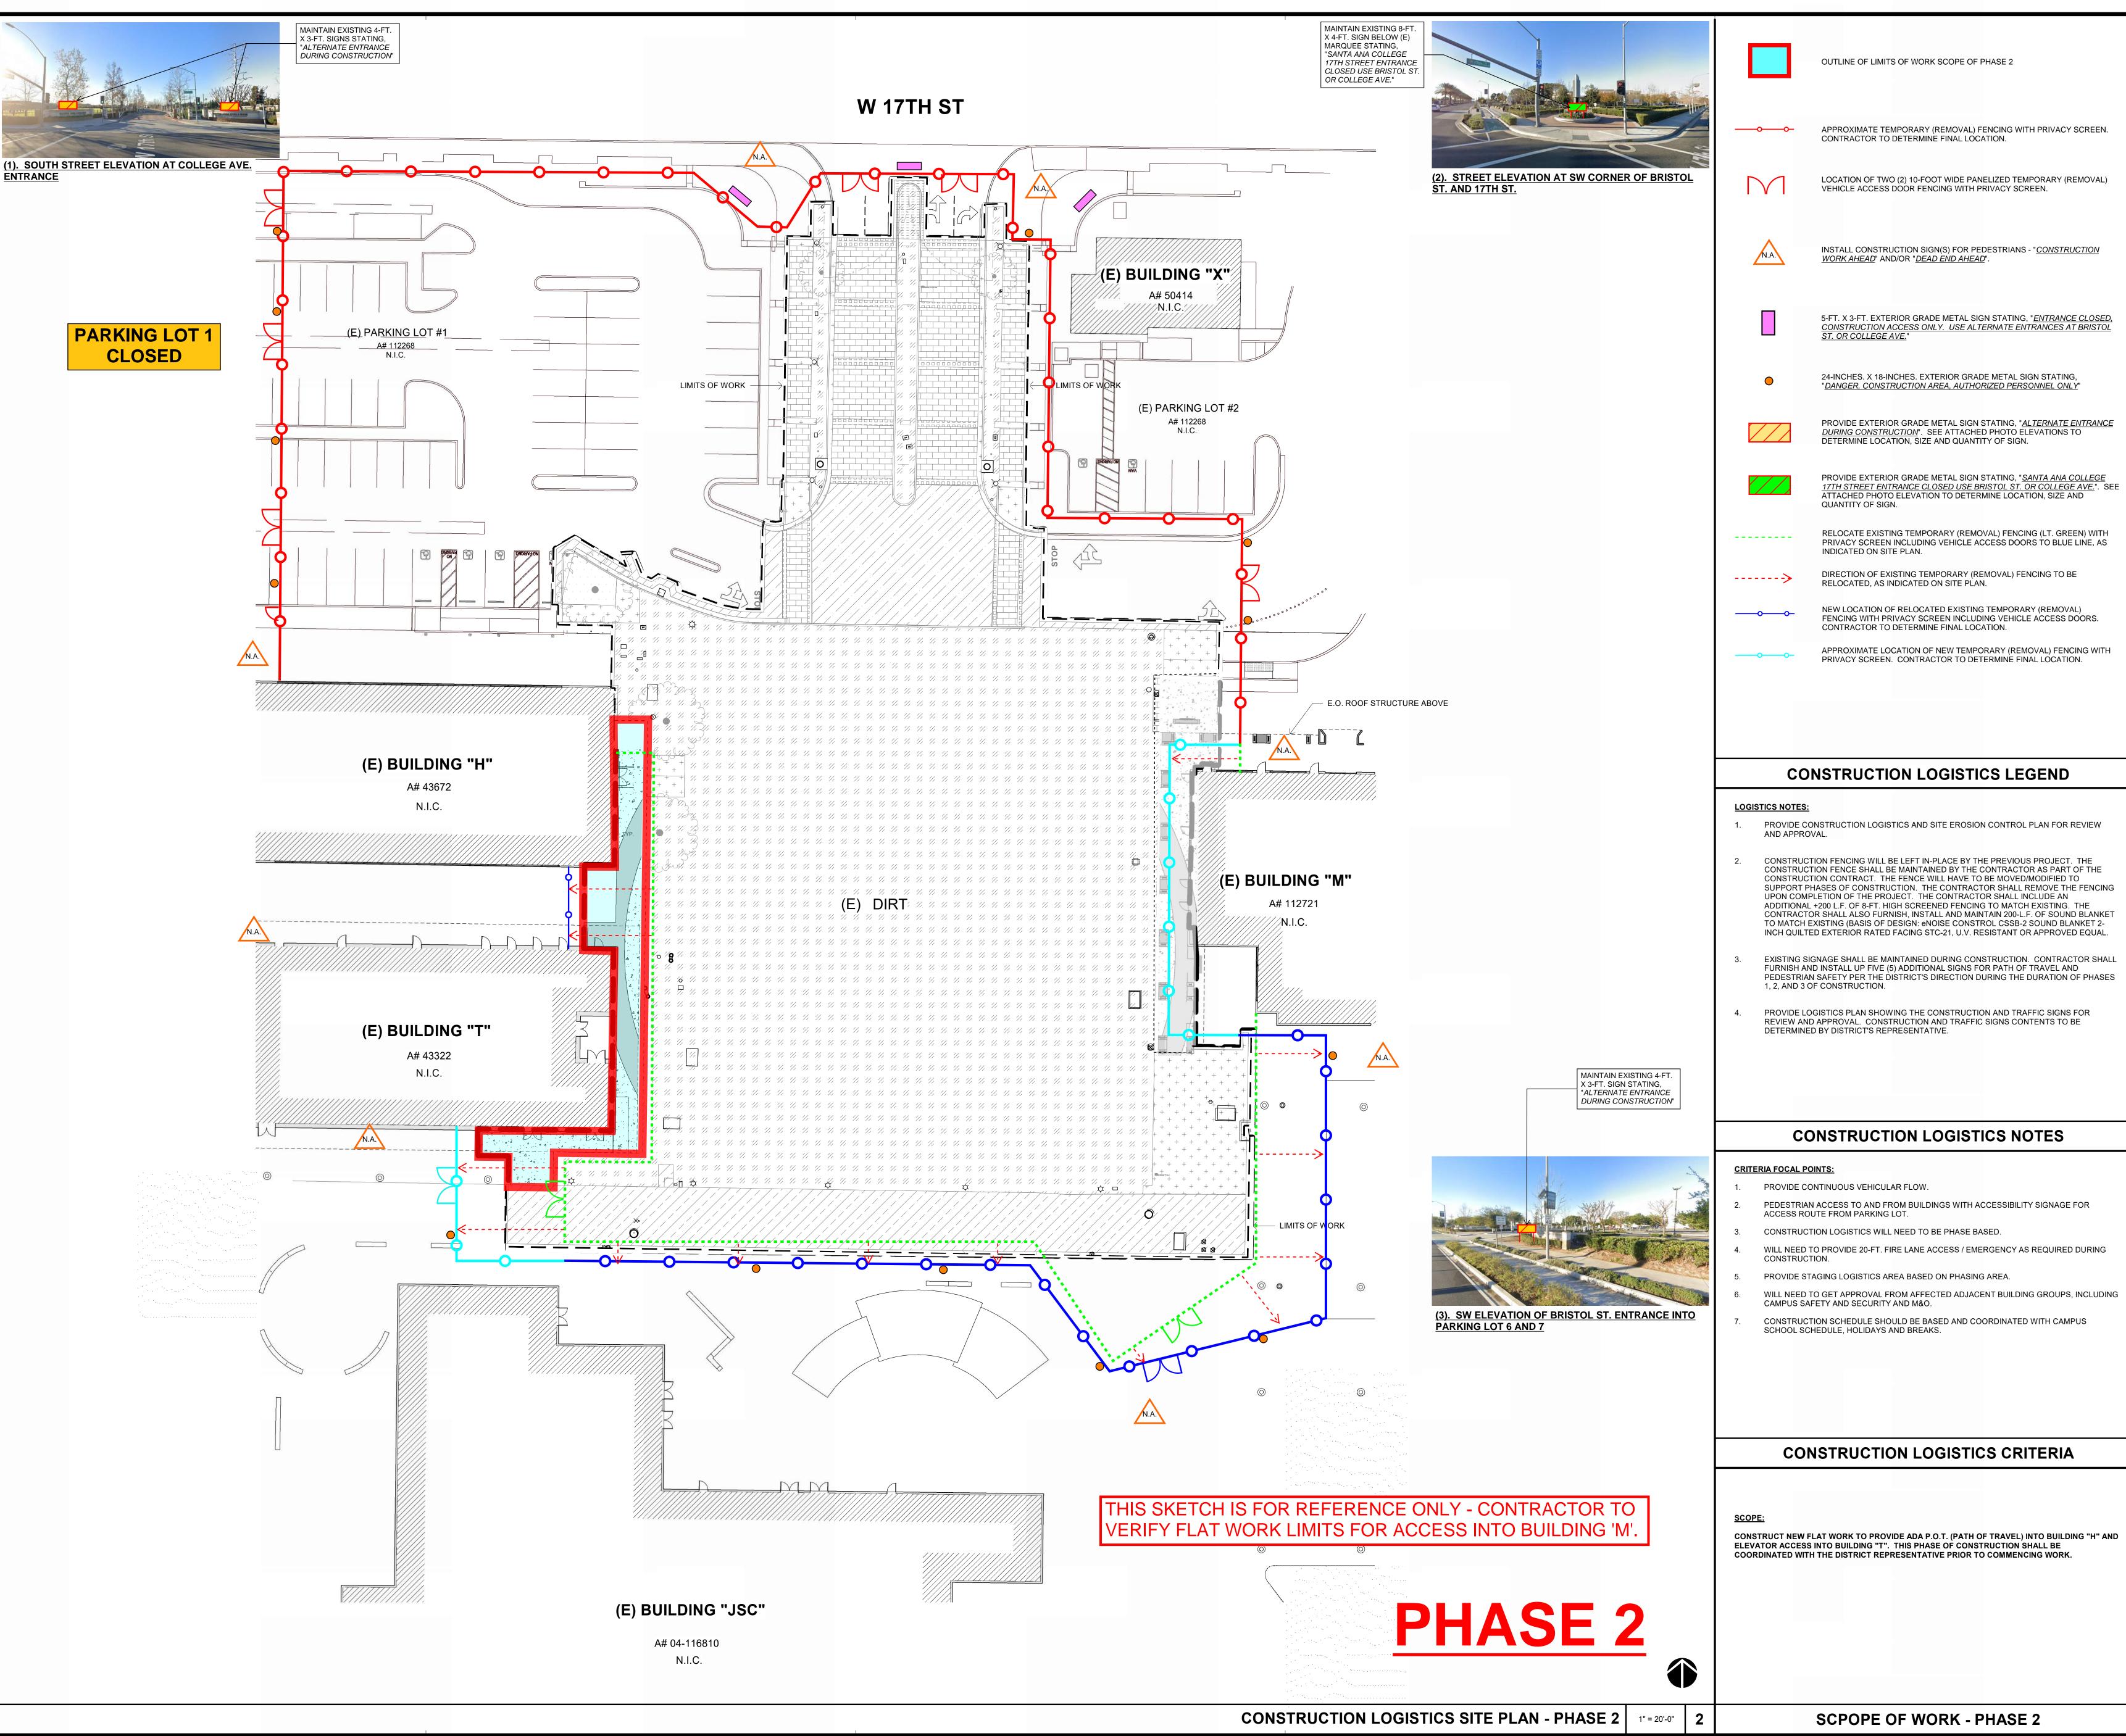

**REVISIONS:** 

**DATE ISSUED:** 

PROJECT NO:

SHEET TITLE:

PHASE 2

SCALE:

SHEET NUMBER:

**DSA APPLICATION NO:** 04-122485

CONSTRUCTION

LOGISTICS PLN -

DESCRIPTION

DATE

2021-07-19

2020-40160

As indicated

GEN-6

# CONSTRUCTION LOGISTICS NOTES

# **CRITERIA FOCAL POINTS:**

PROVIDE CONTINUOUS VEHICULAR FLOW.

- PEDESTRIAN ACCESS TO AND FROM BUILDINGS WITH ACCESSIBILITY SIGNAGE FOR
- CONSTRUCTION LOGISTICS WILL NEED TO BE PHASE BASED.
- WILL NEED TO PROVIDE 20-FT. FIRE LANE ACCESS / EMERGENCY AS REQUIRED DURING
- PROVIDE STAGING LOGISTICS AREA BASED ON PHASING AREA.
- WILL NEED TO GET APPROVAL FROM AFFECTED ADJACENT BUILDING GROUPS, INCLUDING CAMPUS SAFETY AND SECURITY AND M&O.
- CONSTRUCTION SCHEDULE SHOULD BE BASED AND COORDINATED WITH CAMPUS SCHOOL SCHEDULE, HOLIDAYS AND BREAKS.

# **CONSTRUCTION LOGISTICS CRITERIA**

CONSTRUCT NEW FLAT WORK TO PROVIDE ADA P.O.T. (PATH OF TRAVEL) INTO BUILDING "H" AND ELEVATOR ACCESS INTO BUILDING "T". THIS PHASE OF CONSTRUCTION SHALL BE COORDINATED WITH THE DISTRICT REPRESENTATIVE PRIOR TO COMMENCING WORK.




THIS DOCUMENT CONTAINS INFORMATION PROPRIETARY TO SVA ARCHITECTS NC. AND IS FURNISHED IN CONFIDENCE FOR THE LIMITED PURPOSE OF

NOT BE USED FOR ANY OTHER PURPOSE AND MAY NOT BE REPRODUCED OR

DISCLOSED TO OTHERS WITHOUT THE PRIOR WRITTEN CONSENT OF SVA ARCHITECTS INC. ALL RIGHTS RESERVED, © COPYRIGHT 2020.

**SCPOPE OF WORK - PHASE 2** 

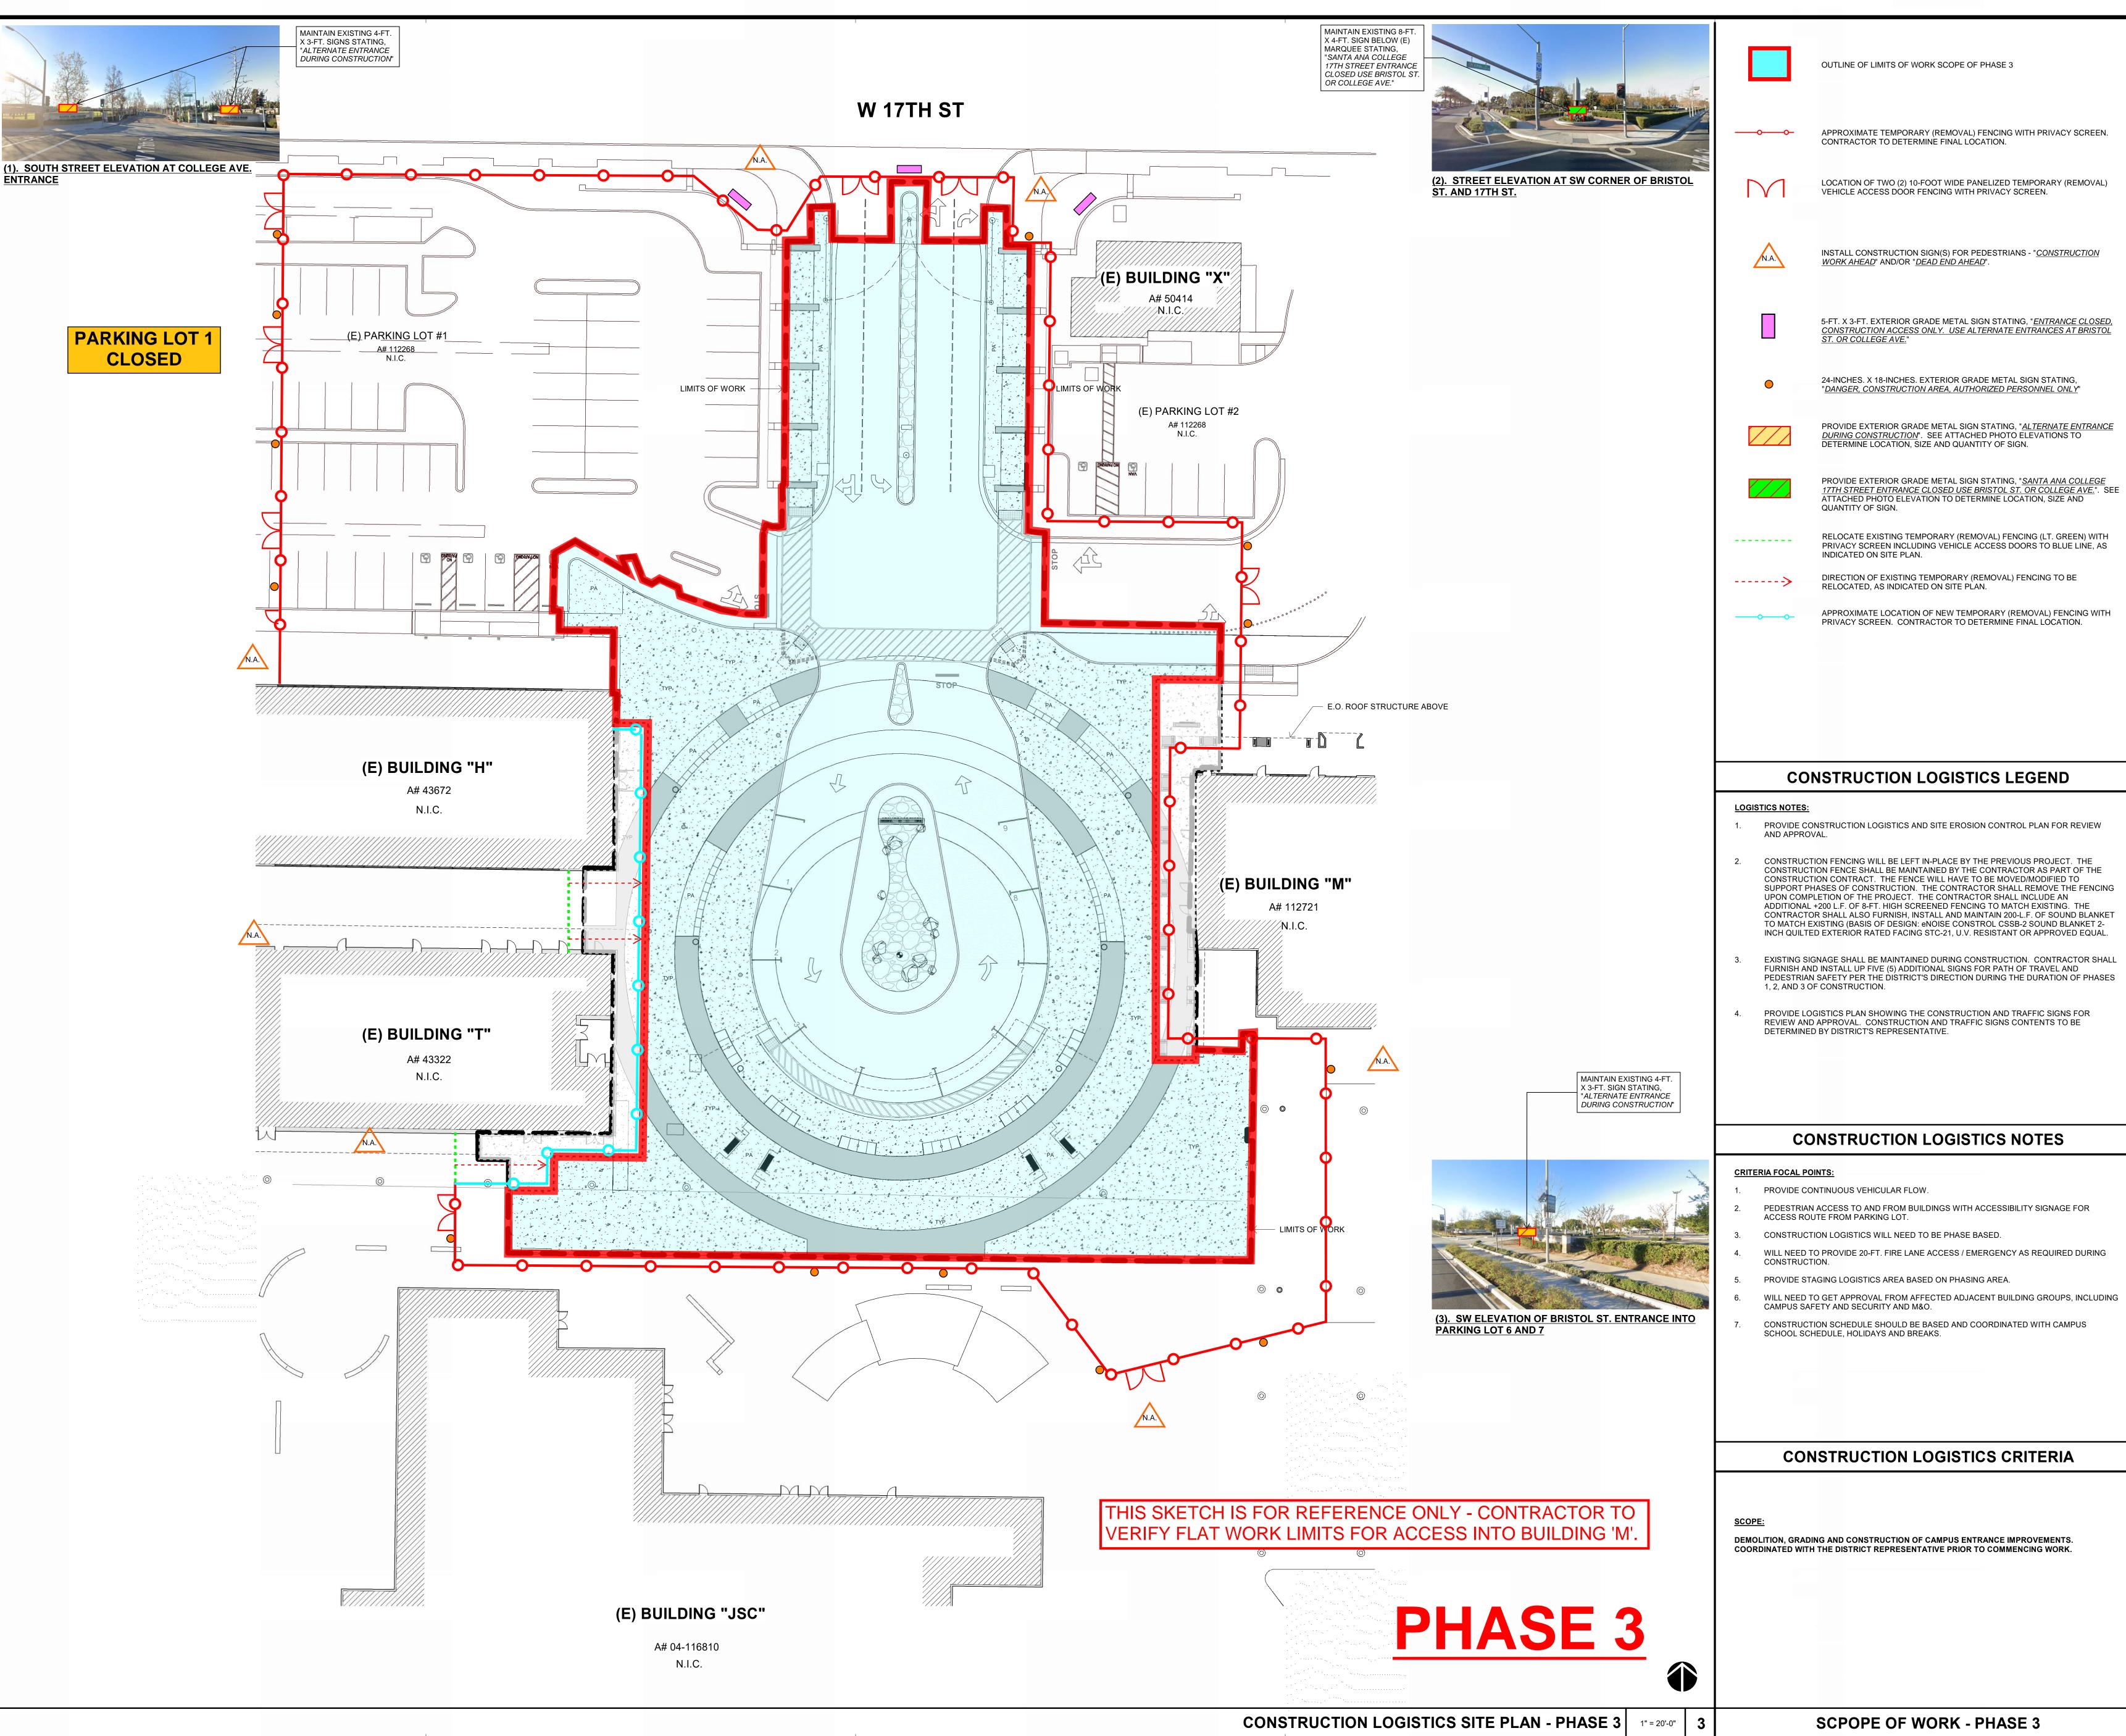

**DSA APPLICATION NO:** 04-122485

CONSTRUCTION

LOGISTICS PLN -

DESCRIPTION

DATE

2021-07-19

2020-40160

As indicated

GEN-7

**REVISIONS:** 

**DATE ISSUED:** 

PROJECT NO:

SHEET TITLE:

PHASE 3

SCALE:

SHEET NUMBER:

# **CONSTRUCTION LOGISTICS NOTES**

PROVIDE CONTINUOUS VEHICULAR FLOW.

- PEDESTRIAN ACCESS TO AND FROM BUILDINGS WITH ACCESSIBILITY SIGNAGE FOR ACCESS ROUTE FROM PARKING LOT.
- CONSTRUCTION LOGISTICS WILL NEED TO BE PHASE BASED.
- WILL NEED TO PROVIDE 20-FT. FIRE LANE ACCESS / EMERGENCY AS REQUIRED DURING
- PROVIDE STAGING LOGISTICS AREA BASED ON PHASING AREA. WILL NEED TO GET APPROVAL FROM AFFECTED ADJACENT BUILDING GROUPS, INCLUDING CAMPUS SAFETY AND SECURITY AND M&O.
- CONSTRUCTION SCHEDULE SHOULD BE BASED AND COORDINATED WITH CAMPUS SCHOOL SCHEDULE, HOLIDAYS AND BREAKS.

# **CONSTRUCTION LOGISTICS CRITERIA**

DEMOLITION, GRADING AND CONSTRUCTION OF CAMPUS ENTRANCE IMPROVEMENTS. COORDINATED WITH THE DISTRICT REPRESENTATIVE PRIOR TO COMMENCING WORK.



NOT BE USED FOR ANY OTHER PURPOSE AND MAY NOT BE REPRODUCED OR DISCLOSED TO OTHERS WITHOUT THE PRIOR WRITTEN CONSENT OF SVA ARCHITECTS INC. ALL RIGHTS RESERVED, © COPYRIGHT 2020.

**SCPOPE OF WORK - PHASE 3** 

# SUPPLEMENTARY CONDITIONS

- 1. Article 8 Liquidated Damages: Liquidated Damages shall be in the following sum(s) and in accordance with Article 8:
  - 1) One Thousand Five Hundred Dollars (\$1,500.00) per day as liquidated damages for each and every day's delay beyond the Substantial Completion Date for each phase; plus
  - 2) <u>Three Hundred Dollars (\$300.00)</u> per day as liquidated damages for each and every day's delay after the Final Completion Date for each phase.
- **2. Article 9 Schedule**: Construction Schedule for the Project is as follows:
  - 1) It is hereby understood that the Contractor will meet the following schedule milestones:
    - a) The Contractor shall provide District with:
      - i) Submittal Schedule, for the District's consideration and approval, within <u>ten (10)</u> calendar days from NTP.
      - ii) Schedule of Values, for the District's consideration and approval, within <u>fifteen (15)</u> <u>calendar days from NTP</u>.
      - iii) Proposed Baseline Construction Schedule, for the District's consideration and approval, within <a href="thirty">thirty</a> (30) calendar days from NTP. Once approved by the District, this Construction Schedule shall be the baseline Construction Schedule (or "Baseline Schedule") that the Contractor shall follow for the Project and which can only be changed by the written approval of the District as indicated in the Contract Documents.

iv) Fully burdened labor rates for each trade within <u>fifteen (15) calendar days from NTP</u> for District review and approval

b) Required Project Milestones:

three hundred and seventy (370) calendar

ADD-3

ADD-3

- i) Installation of contract scope within three hundred and sixty-fix (365) calendar days from NTP. Refer to Specification Sections 011216 and 015000 for further information.
- c) The Substantial Completion Date for the Project shall be three hundred and sixty five (365) calendar days from NTP.

d) The Final Completion Date (or "Completion Date") and five (405) calendar days from NTP. four hundred and ten (410) calendar days

2) It is hereby understood that Governmental Delay for the project is twelve (12) calendar days

and skall only be granted as further described in Article 9.

Governmental Delay shall be included within the overall Contract Time

twenty (20) calendar days

It is hereby understood that the Contract Time is 390 calendar days.

four hundred and ten (410) calendar days

ADD-3

SUPPLEMENTARY CONDITIONS

Rancho Santiago Community College District Bid #1456 Campus Entrance Improvements at Santa Ana College Project ID#3276, DSA#04-122485 Page **107** of **108** 

ADD-3

# 3. Article 26 - Hours of work:

Where a single shift is worked, eight (8) consecutive hours between {7:00AM} and {5:00PM} shall constitute a work day at the applicable prevailing wage rate(s).

To minimize impacts on the instructional environment, there shall be no noise generating work during the final examinations week for five (5) days in the 2024 Fall semester. These days are considered construction "Quiet Days".

ADD-3

# 4. Logistics – Temporary Facilities

- 1) Contractor shall make provisions to allow ADA path of travel access into adjacent buildings during construction. Contractor shall provide a phasing plan showing compliant ADA path of travel. Phasing plan shall be reviewed and approved by District.
- 2) Contractor shall furnish security lighting (with photocells) illuminating the construction area. Lights shall be placed on the roofs of M and T and powered from existing circuits.
- 3) Existing signage shall be maintained during construction. Contractor shall furnish and install up to 5 additional signs for path of travel or safety at District direction. All project signage to be removed at the completion of the project.
- 4) Construction fencing will be left in place by the previous project. (See Logistics Plan for approximate location) The construction fence shall be maintained by the contractor as part of the construction contract. The fence will have to be moved/modified to support multiple phases of construction. The contractor shall remove the fencing upon completion of the project. The contractor shall include an additional 200LF of temporary 8FT high screened fencing to match existing. The contractor should also furnish, install and maintain 200LF of Sound Blanket to match existing (Basis of design: eNoise Control Model CSSB-2 Sound Blanket 2" thick quilted exterior rated facing STC-21, UV Resistant or Approved Equal. All fencing shall be removed and disposed of at the completion of the project

# 5. Hazardous Material- Asbestos Bearing Material Abatement

Contractor shall be responsible to provide all labor and materials to identify, provide containment, package, remove and dispose of up to 100 LF of unidentified underground 12" Dia. ACM bearing pipe, fittings or insulation.